
BELL ATLANTIC MOBILE SYSTEMS LLC. d/b/a



SITE NAME: VAN HORNESVILLE

FUZE ID #: 17302851 MDG #: 5000921062

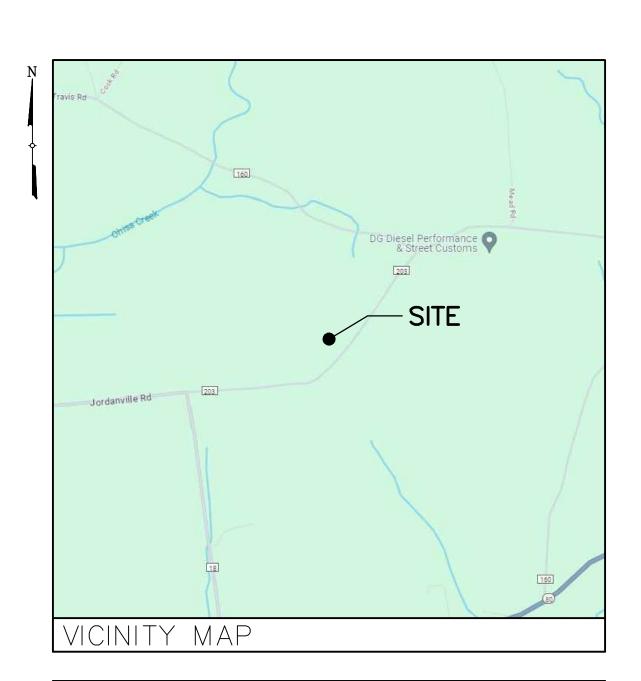

DIRECTIONS

DIRECTIONS TO SITE:

FROM NORTH GREENBUSH FACILITY,

TURN RIGHT ONTO US-4 S AND FOLLOW FOR 1.5± MILES. TURN RIGHT ONTO NY-43 W AND FOLLOW FOR 1.1± MILES. MERGE ONTO I-90 W AND FOLLOW FOR 53.7± MILES. TAKE EXIT 29 TOWARD NY-10 AND FOLLOW FOR 0.7± MILES. TURN RIGHT ONTO E MAIN ST AND FOLLOW FOR 0.4± MILES. CONTINUE ONTO NY-55 W/ERIE BLVD AND FOLLOW FOR 3.2± MILES. CONTINUE ONTO MAIN ST AND FOLLOW FOR 0.3± MILES. CONTINUE ONTO NY-80 W AND FOLLOW FOR 11.0± MILES. TURN RIGHT ONTO TRAVIS RD AND FOLLOW FOR 1.8± MILES. TURN LEFT ONTO PUSKARENKO RD AND FOLLOW FOR 0.4± MILES. SITE WILL BE ON THE RIGHT.

SITE ADDRESS:	PUSKARENKO RD JORDANVILLE, NY 13361
MUNICIPALITY:	TOWN OF STARK
COUNTY:	HERKIMER
TAX MAP NUMBER:	134.3-1-9
ZONING DISTRICT:	N/A
STRUCTURE COORDINATES:	42.910413° -74.833202°
GROUND ELEVATION:	1551.2'± AMSL
PROPERTY OWNER:	SPRING LAWN FARM LLC 3993 JORDANVILLE RD JORDANVILLE, NY 13361
APPLICANT:	VERIZON WIRELESS 1275 JOHN STREET, SUITE 100 WEST HENRIETTA, NY 14586
CONTACT PERSON:	GREGORY HANLEY
CONTACT PHONE:	(315) 701-4621
PROJECT SUMMAR	· · · · · · · · · · · · · · · · · · ·

DESCRIPTION

THE PROPOSED WORK CONSISTS OF INSTALLING CELLULAR ANTENNAS AND RELATED EQUIPMENT ON A PROPOSED SELF SUPPORT TOWER AND THE INSTALLATION OF EQUIPMENT AT GRADE WITHIN A PROPOSED FENCED COMPOUND. PROJECT INCLUDES A NEW GRAVEL ACCESS DRIVE AND UNDERGROUND POWER AND FIBER UTILITIES TO SERVICE THE

SHT. NO.	DESCRIPTION	REV NO	REVISION DATE
T-1	TITLE SHEET	1	6/5/24
GN-1 GN-2	GENERAL NOTES GENERAL NOTES	1 1	6/5/24 6/5/24
C-1 C-2	OVERALL SITE PLAN SITE DETAIL PLAN	1 1	6/5/24
C-3 C-4 C-5A	ELEVATION, ORIENTATION PLAN & RF INFO ANTENNA MOUNTING DETAILS SITE DETAILS	1 1 1	6/5/24 6/5/24
C-5A C-5B C-6	SITE DETAILS SITE DETAILS EQUIPMENT ELEVATIONS	1 1	6/5/24 6/5/24 6/5/24
C-7 C-8	FOUNDATION PLAN & DETAILS PIER DETAILS	1 1	6/5/24
C-9	ICE CANOPY DETAILS	1	6/5/24
E-1 E-2	UTILITY DIAGRAMS & DETAILS UTILITY BACKBOARD DETAIL	1 1	6/5/24
E-2 E-3 E-4	GROUNDING PLAN GROUNDING RISER DIAGRAM	1 1	6/5/24 6/5/24 6/5/24
E-5	GROUNDING DETAILS	1	6/5/24
SHE	EET INDEX		

THIS SET OF PLANS SHALL NOT BE UTILIZED AS CONSTRUCTION DOCUMENTS

UNTIL ALL ITEMS OF CONCERN HAVE BEEN ADDRESSED AND EACH OF THE

DRAWINGS HAS BEEN REVISED AND ISSUED "FOR CONSTRUCTION".

Before You Dig, Drill Or Blast! CALL US TOLL FREE 811 OR 1-800-962-7962 UDIGNY - NEW YORK

DO NOT SCALE DRAWINGS

THESE DRAWINGS ARE FORMATTED FOR 22"x34" FULL SIZE AND 11"x17 HALF SIZE. OTHER SIZED VERSIONS ARE NOT PRINTED TO THE SCALE SHOWN. CONTRACTOR SHALL VERIFY ALL PLANS, EXISTING DIMENSIONS & CONDITIONS ON THE JOB SITE & SHALL IMMEDIATELY NOTIFY THE ENGINEER IN WRITING OF ANY DISCREPANCIES BEFORE PROCEEDING WIT THE WORK OR BE RESPONSIBLE FOR SAME.

UNDERGROUND FACILITIES PROTECTIVE ORGANIZATION

NY industrial code rule 753 requires no less than two

working days notice, but not more than ten days notice



1275 JOHN STREET, SUITE 100 WEST HENRIETTA, NY 14586



6/5/24 UPDATED PER 1A

RELEASED BY



BEARING THE SEAL OF A LICENSED ENGINEER OR LAND SURVEYOR IS A VIOLATION OF SECTION 7209 SUBDIVISION 2 OF THE NEW YORK STATE EDUCATION

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> ORIGINAL SIZE IN INCHES SITE INFORMATION

VAN HORNESVILLE FUZE ID#: 17302851 MDG#: 5000921062

SITE ADDRESS

PUSKARENKO RD TOWN OF STARK HERKIMER COUNTY NY 13361

SHEET TITLE

TITLE SHEET

SHEET NUMBER

FENCING NOTES

- 1. CORNER POSTS, PULL POSTS, AND END POSTS SHALL BE 3" NOMINAL O.D., SCHEDULE 40, STEEL PIPE CONFORMING WITH ASTM F-1083. GATE POSTS SHALL BE 4" NOMINAL O.D., SCHEDULE 40, STEEL PIPE CONFORMING WITH ASTM F-1083 AND MAY BE UTILIZED FOR SINGLE GATE OPENING WIDTHS OF 6 FEET OR LESS AND FOR DOUBLE GATE OPENING WIDTHS OF 12 FEET OR LESS.
- 2. LINE POSTS SHALL BE 2" NOMINAL O.D. SCHEDULE 40 STEEL PIPE CONFORMING WITH ASTM F-1083.
- 3. TOP RAIL AND BRACE RAIL SHALL BE 1 5/8" NOMINAL O.D. PIPE CONFORMING WITH ASTM F-1083.
- 4. GATE FRAMES SHALL BE FABRICATED FROM 1 1/2" NOMINAL O.D. PIPE CONFORMING WITH ASTM F-1083.
- 5. FENCE FABRIC SHALL BE 9 GAUGE WIRE SIZE, 2" MESH CHAIN LINK FENCE CONFORMING WITH ASTM A-392.
- 6. TIE WIRE SHALL BE AS FOLLOWS:
- a) AT POSTS, RAILS, AND WHERE NECESSARY ON GATE FRAMES: MINIMUM 11 GAUGE GALVANIZED STEEL SPACED AT NOT LESS THAN 14" ON CENTER.
- b) AT TENSION WIRES: BY HOG RINGS SPACED AT NOT LESS THAN 24" ON CENTER.
- 7. TENSION WIRE SHALL BE 7 GAUGE GALVANIZED STEEL.
- 8. THE GATE LATCH SHALL BE THE MALLEABLE IRON FORK TYPE AS MANUFACTURED BY PAGE WILSON AS THEIR TYPE 75 GATE LATCH ASSEMBLY, OR EQUAL. PAD LOCKS ARE TO BE PROVIDED BY THE OWNER.
- 9. FENCE SHALL BE INSTALLED IN ACCORDANCE WITH ASTM F-567 AND GATES SHALL BE INSTALLED IN ACCORDANCE WITH ASTM F-900.

LEGEND PROPERTY LINE ADJOINING PROPERTY LINE EXISTING CONTOUR EXISTING INDEX CONTOUR EXISTING BRUSH LINE EXISTING TREE LINE EXISTING EDGE OF PAVEMENT EXISTING EDGE OF GRAVEL DRIVE **EXISTING FENCE** EXISTING UNDERGROUND UTILITIES EXISTING OVERHEAD WIRES EXISTING UTILITY POLE EXISTING IRON ROD/PIPE EXISTING CENTERLINE OF DITCH EXISTING STORM SEWER EXISTING CATCH BASIN PROPOSED LEASE LINE PROPOSED EASEMENT LINE PROPOSED CHAINLINK FENCE PROPOSED SILT FENCE ___ o ___ o ___ o __ PROPOSED UNDERGROUND UTILITIES ______ PROPOSED FUTURE U/G UTILITIES TREE TO BE REMOVED TREE TO REMAIN PROPOSED LIMITS OF CLEARING

CONCRETE NOTES

- DESIGN AND CONSTRUCTION OF ALL CONCRETE SHALL CONFORM TO THE AMERICAN CONCRETE INSTITUTE "BUILDING CODE REQUIREMENTS FOR REINFORCED CONCRETE"
- . ULTIMATE COMPRESSIVE STRENGTH OF CONCRETE AT 28 DAYS SHALL BE 4500 PSI.
- 3. CEMENT SHALL BE PORTLAND CEMENT CONFORMING TO ASTM C150 TYPE I OR II.
- 4. REINFORCING STEEL SHALL BE DEFORMED BARS CONFORMING TO ASTM A615, GRADE 60, "DEFORMED AND PLAIN BILLET STEEL BARS FOR CONCRETE REINFORCEMENT".
- 5. WELDED WIRE FABRIC SHALL CONFORM TO ASTM A185, "WELDED STEEL WIRE FABRIC PLAIN FOR CONCRETE REINFORCEMENT".
- 6. CONCRETE WORK AND MATERIALS SHALL CONFORM TO THE AMERICAN CONCRETE INSTITUTE "SPECIFICATIONS FOR STRUCTURAL CONCRETE FOR BUILDINGS", ACI 301.
- 7. SUBMIT CONCRETE MIX DESIGN TO THE DESIGN ENGINEER FOR APPROVAL NOT LESS THAN 3 DAYS PRIOR TO CONSTRUCTION. MIX DESIGN SHALL BE APPROVED BY THE ENGINEER PRIOR TO PLACEMENT OF CONCRETE.
- B. READY MIX CONCRETE SHALL COMPLY WITH ACI 304 AND ASTM C94 WITH A MAXIMUM WATER—CEMENT RATIO OF 0.50. TIME BETWEEN INTRODUCTION OF WATER AND THE PLACEMENT OF CONCRETE SHALL NOT EXCEED 1—1/2 HOURS.
- CONCRETE AGGREGATES SHALL BE NORMAL WEIGHT, CONFORMING TO ASTM C33.
 MAXIMUM SIZE OF COARSE AGGREGATE SHALL BE 3/4".
- 10. CHLORIDE-CONTAINING ADMIXTURES SHALL NOT BE USED
- 11. CONCRETE SLUMP SHALL NOT EXCEED 5 INCHES UNLESS SPECIFICALLY AUTHORIZED BY THE ENGINEER. SLUMP SHALL BE DETERMINED IN ACCORDANCE WITH ASTM C143.
- 12. PROVIDE AIR ENTRAINMENT IN EXTERIOR EXPOSED CONCRETE TO OBTAIN TOTAL AIR CONTENT OF $5\% \pm 1\%$ IN ACCORDANCE WITH ACI 301.
- 13. FOR CONCRETE CAST AGAINST AND PERMANENTLY EXPOSED TO EARTH, CONCRETE COVER FOR REINFORCING SHALL BE: 3" FOR ALL BARS FOR CONCRETE EXPOSED TO EARTH OR WEATHER, MINIMUM COVER SHALL BE: 2" FOR #6 AND LARGER BARS 1-1/2" FOR #5 AND SMALLER BARS OR WIRE FABRIC
- 14. LAP SPLICES FOR REINFORCING SHALL BE IN ACCORDANCE WITH ACI 318.12 AND STANDARD HOOKS SHALL CONFORM TO ACI 318.7.
- 15. WELDING OF REINFORCING STEEL OR THE APPLICATION OF HEAT TO FACILITATE BENDING IS SPECIFICALLY PROHIBITED.
- 16. ALL REINFORCING, ANCHOR BOLTS, DOWELS, EMBEDDED STEEL, INSERTS AND ALL OTHER EMBEDDED ITEMS AND FORMED DETAILS SHALL BE IN PLACE BEFORE START OF CONCRETE PLACEMENT.
- 17. PROVIDE A 3/4" CHAMFER AT ALL EXPOSED EDGES OF CONCRETE, UNLESS OTHERWISE NOTED.
- 18. PROVIDE NOT LESS THAN 48 HOURS NOTICE TO THE FIELD REPRESENTATIVE PRIOR TO PLACEMENT OF CONCRETE.

19. WHEN AMBIENT TEMPERATURE IS BELOW 50 DEGREES F, CONCRETE MATERIALS AND

- PLACEMENT SHALL CONFORM TO THE RECOMMENDATIONS OF ACI 306R "COLD WEATHER CONCRETING".

 20. WHEN AMBIENT TEMPERATURE IS ABOVE 90 DEGREES F, CONCRETE MATERIALS AND
- 21. REMOVE ALL LOOSE MATERIAL AND DEBRIS FROM COMPACTED SUBGRADE SURFACE PRIOR TO PLACING CONCRETE. CONCRETE SHALL NOT BE PLACED ON FROZEN SUBGRADE.

PLACEMENT SHALL CONFORM TO THE RECOMMENDATIONS OF ACI 305R "HOT

WEATHER CONCRETING".

- 22. CONCRETE SHALL BE SUFFICIENTLY CONSOLIDATED BY VIBRATION TO REMOVE AIR VOIDS. VIBRATION SHALL BE IN ACCORDANCE WITH ACI 309 "STANDARD PRACTICE FOR CONSOLIDATION OF CONCRETE".
- 23. THE TOP OF ALL CONCRETE SURFACES SHALL BE TRUE AND LEVEL WITH A SMOOTH FLOAT FINISH, UNLESS OTHERWISE NOTED. ALL DIMENSIONS SHALL BE WITHIN ± 1/8
- 24. TESTING OF CONCRETE SHALL BE PERFORMED IN ACCORDANCE WITH ACI 318. REQUIRED, TESTING OF CONCRETE SHALL BE PERFORMED UNDER THE DIRECTION OF THE CONSTRUCTION MANAGER.
- 25. THROUGHOUT CONSTRUCTION, THE CONCRETE WORK SHALL BE ADEQUATELY PROTECTED AGAINST DAMAGE DUE TO EXCESSIVE LOADING, CONSTRUCTION EQUIPMENT, MATERIALS OR METHODS, ICE, RAIN, OR SNOW. PROTECT CONCRETE FROM EXCESSIVE HEAT AND FREEZING FOR NOT LESS THAN 14 DAYS.
- 26. DRYING OUT OF CONCRETE, ESPECIALLY DURING THE FIRST 24 HOURS, SHALL BE CAREFULLY GUARDED AGAINST. ALL SURFACES SHALL BE MOIST CURED OR PROTECTED USING A MEMBRANE CURING AGENT CONFORMING TO ASTM C309 APPLIED AS SOON AS FORMS ARE REMOVED. IF MEMBRANE CURING AGENT IS USED, EXERCISE CARE NOT TO DAMAGE SURFACE.
- 27. CONTRACTOR SHALL BRING TO THE IMMEDIATE ATTENTION OF THE CONSTRUCTION MANAGER ANY DEFECTS OR ERRORS IN THE WORK, PRIOR TO MAKING REPAIRS. CONTRACTOR SHALL OBTAIN PERMISSION FROM THE CONSTRUCTION MANAGER TO PATCH OR OTHERWISE REPAIR DEFECTS OTHER THAN MINOR HONEYCOMBING.
- 28. FABRIC AND STONE SHALL BE INSTALLED THE ENTIRE LENGTH AND WIDTH BENEATH THE PLATFORM.
- 29. JOINT FILLER SHALL BE PREFORMED RESILIENT BITUMINOUS EXPANSION JOINT FILLER CONFORMING TO ASTM D1751.
- 30. EXTERIOR WALKING SURFACES SHALL RECEIVE A BROOM FINISH.
- 31. GROUT SHALL BE NON METALLIC, NON SHRINK PREPACKAGED GROUT WITH A MINIMUM COMPRESSIVE STRENGTH OF 5000 PSI AT 28 DAYS. GROUT SHALL BE FIVE STAR GROUT AS MANUFACTURED BY FIVE STAR PRODUCTS, FAIRFIELD, CT OR APPROVED EQUAL.
- 32. CONCRETE ANCHORS SHALL BE HEADED STEEL STUDS MEETING THE REQUIREMENTS
 OF ASTM A108 "STEEL BARS, CARBON, COLD FINISHED, STANDARD QUALITY".

SITE NOTES

- 1. ALL SITE WORK SHALL BE AS INDICATED ON THE DRAWINGS.
- 2. RUBBISH, STUMPS, DEBRIS, STICKS, STONES AND OTHER REFUSE SHALL BE REMOVED FROM THE SITE AND DISPOSED OF LEGALLY.
- 3. THE SITE SHALL BE GRADED TO CAUSE SURFACE WATER TO FLOW AWAY FROM THE PROPOSED PLATFORM.
- 4. NO FILL OR EMBANKMENT MATERIAL SHALL BE PLACED ON FROZEN GROUND FROZEN MATERIALS, SNOW OR ICE SHALL NOT BE PLACED IN ANY FILL OR EMBANKMENT.
- 5. THE SUBGRADE SHALL BE COMPACTED AND BROUGHT TO A SMOOTH UNIFORM GRADE PRIOR TO FINISHED SURFACE APPLICATION.
- 6. ALL EXISTING ACTIVE SEWER, WATER, GAS, ELECTRIC, AND OTHER UTILITIES WHERE ENCOUNTERED IN THE WORK, SHALL BE PROTECTED AT ALL TIMES, AND WHERE REQUIRED FOR THE PROPER EXECUTION OF THE WORK, SHALL BE RELOCATED AS DIRECTED BY THE ENGINEER. EXTREME CAUTION SHOULD BE USED BY THE CONTRACTOR WHEN EXCAVATING OR PIER DRILLING AROUND OR NEAR UTILITIES.
- 7. ALL EXISTING INACTIVE SEWER, WATER, GAS, ELECTRIC AND OTHER UTILITIES, WHICH INTERFERE WITH THE EXECUTION OF THE WORK, SHALL BE REMOVED AND/OR CAPPED, PLUGGED OR OTHERWISE DISCONTINUED AT POINTS WHICH WILL NOT INTERFERE WITH THE EXECUTION OF THE WORK, SUBJECT TO THE APPROVAL OF THE ENGINEER.
- 8. THE AREAS OF THE OWNERS PROPERTY DISTURBED BY THE WORK SHALL BE GRADED TO A UNIFORM SLOPE, FERTILIZED, SEEDED, AND COVERED WITH MULCH.
- CONTRACTOR SHALL MINIMIZE DISTURBANCE TO EXISTING SITE DURING CONSTRUCTION. EROSION CONTROL MEASURES, IF REQUIRED DURING CONSTRUCTION, SHALL BE IN CONFORMANCE WITH THE STATE GUIDELINES AND ANY LOCAL REGULATIONS.
- 10. ALL RESTORATION ISSUES SHALL BE COMPLETED WITHIN 72 HOURS OF THE COMPLETION OF THE WORK ACTIVITY OR WITHIN A REASONABLE AMOUNT OF TIME AS DIRECTED BY CONSTRUCTION MANAGER/ENGINEER.
- 11. CARE SHALL BE TAKEN TO RETAIN NATURAL GROWTH AND PREVENT DAMAGE TO TREES WITHIN AND OUTSIDE THE LIMITS OF CONSTRUCTION AND SPECIFIED WORK AREAS CAUSED BY EQUIPMENT AND MATERIALS. ANY DAMAGE TO THIS NATURAL GROWTH SHALL BE RESTORED AT THE EXPENSE OF THE CONTRACTOR.
- 12. ALL AREAS DISTURBED BY THE CONTRACTOR WITHOUT AUTHORIZATION SHALL BE RESTORED BY THE CONTRACTOR.
- 13. IN THE EVENT THE CONTRACTOR DAMAGES AN EXISTING UTILITY SERVICE CAUSING AN INTERRUPTION IN SAID SERVICE, HE SHALL IMMEDIATELY COMMENCE WORK TO RESTORE SERVICE AND MAY NOT CONTINUE HIS WORK OPERATION UNTIL SERVICE IS RESTORED.

ANTENNA MOUNTING NOTES

- I. THE DESIGN AND CONSTRUCTION OF ANTENNA SUPPORTS SHALL CONFORM TO ANSI/TIA-222 H-2017 "STRUCTURAL STANDARD FOR ANTENNA SUPPORTING STRUCTURES, ANTENNAS AND SMALL WIND TURBINE SUPPORT STRUCTURES," THE BUILDING CODE OF NEW YORK STATE, AND ALL OTHER APPLICABLE LOCAL, STATE, AND FEDERAL CODES.
- 2. ALL STEEL MATERIALS SHALL BE GALVANIZED AFTER FABRICATION IN ACCORDANCE WITH ASTM A123 "ZINC (HOT-DIP GALVANIZED) COATINGS ON IRON AND STEEL PRODUCTS", UNLESS OTHERWISE NOTED.
- 3. ALL BOLTS, ANCHORS AND MISCELLANEOUS HARDWARE SHALL BE GALVANIZED IN ACCORDANCE WITH ASTM A153 "ZINC—COATING (HOT—DIP) ON IRON AND STEEL HARDWARE", UNLESS OTHERWISE NOTED.
- 4. DAMAGED GALVANIZED SURFACES SHALL BE REPAIRED BY COLD GALVANIZING IN ACCORDANCE WITH ASTM A780 "REPAIR OF DAMAGED AND UNCOATED AREAS OF HOT—DIP GALVANIZED COATINGS", USING COLD GALVANIZING COMPOUND AS MANUFACTURED BY ZINGA—USA OR ZINC KOTE, OR ENGINEER APPROVED EQUAL WITH A MINIMUM METALLIC ZINC CONTENT OF 95% BY WEIGHT IN DRY FILM. DRY FINISHED COATING THICKNESS SHALL BE 3 MILS MINIMUM.
- 5. ALL ANTENNA MOUNTS SHALL BE INSTALLED WITH DOUBLE NUTS AND SHALL BE INSTALLED IN ACCORDANCE WITH MANUFACTURER'S SPECIFICATIONS.
- 6. DESIGN OF THE ANTENNA MOUNTING BRACKETS, SUPPORTS, AND ALL COMPONENTS THEREOF AND ATTACHMENT THERETO SHALL BE THE RESPONSIBILITY OF THE MANUFACTURER. MANUFACTURER SHALL PROVIDE THE OWNER DRAWINGS DETAILING ALL COMPONENTS OF THE ASSEMBLY, INCLUDING CONNECTIONS, DESIGN LOADS, AND ALL OTHER PERTINENT DATA. MANUFACTURER SHALL ALSO PROVIDE THE OWNER WITH A STATEMENT OF COMPLIANCE, INDICATING THAT THE ANTENNA SUPPORTS HAVE BEEN DESIGNED IN ACCORDANCE WITH ANSI/TIA-222-H-2017 STANDARDS. ALL SUBMISSIONS SHALL BEAR THE SIGNATURE AND SEAL OF A PROFESSIONAL ENGINEER LICENSED IN THE STATE OF NEW YORK.

STRUCTURAL NOTES

- PROPOSED TOWER AND FOUNDATION TO BE ANALYZED BY A PROFESSIONAL ENGINEER LICENSED IN THE STATE OF NEW YORK.
- 2. THE VERIFICATION OF STRUCTURAL ADEQUACY AND DESIGN OF THE ATTACHMENTS MUST BE PERFORMED, PRIOR TO THE COMMENCEMENT OF CONSTRUCTION, BY A PROFESSIONAL ENGINEER LICENSED IN THE STATE OF NEW YORK.
- 3. THE DESIGN AND CONSTRUCTION OF ANTENNA SUPPORTS SHALL CONFORM TO ANSI/TIA-222-H-2017 "STRUCTURAL STANDARDS FOR ANTENNA SUPPORTING STRUCTURES, ANTENNAS AND SMALL WIND TURBINE SUPPORT STRUCTURES".

GENERAL NOTES

- 1. ALL WORK SHALL CONFORM TO THE REQUIREMENTS OF THE NEW YORK STATE BUILDING CODE, AND ALL OTHER APPLICABLE CODES AND ORDINANCES.
- 2. CONTRACTOR SHALL VISIT THE JOB SITE AND FAMILIARIZE HIMSELF WITH ALL CONDITIONS AFFECTING THE PROPOSED WORK AND MAKE PROVISIONS AS TO THE COST THEREOF. CONTRACTOR SHALL BE RESPONSIBLE FOR FAMILIARIZING HIMSELF WITH ALL CONTRACT DOCUMENTS, FIELD CONDITIONS AND DIMENSIONS AND CONFIRMING THAT THE WORK MAY BE ACCOMPLISHED AS SHOWN PRIOR TO PROCEEDING WITH CONSTRUCTION. ANY DISCREPANCIES SHALL BE BROUGHT TO THE ATTENTION OF THE ENGINEER PRIOR TO THE COMMENCEMENT OF WORK.
- 3. PLANS ARE NOT TO BE SCALED. THESE PLANS ARE INTENDED TO BE A DIAGRAMMATIC OUTLINE ONLY, UNLESS OTHERWISE NOTED. THE WORK SHALL INCLUDE FURNISHING MATERIALS, EQUIPMENT, APPURTENANCES, AND LABOR NECESSARY TO EFFECT ALL INSTALLATIONS AS INDICATED ON THE DRAWINGS.
- 4. DIMENSIONS SHOWN ARE TO FINISH SURFACES, UNLESS OTHERWISE NOTED. SPACING BETWEEN EQUIPMENT IS REQUIRED CLEARANCE. THEREFORE, IT IS CRITICAL TO FIELD VERIFY DIMENSIONS. SHOULD THERE BE ANY QUESTIONS REGARDING THE CONTRACT DOCUMENTS, EXISTING CONDITIONS AND/OR DESIGN INTENT, THE CONTRACTOR SHALL BE RESPONSIBLE FOR OBTAINING A CLARIFICATION FROM THE CARRIER'S AUTHORIZED REPRESENTATIVE OR THE ENGINEER PRIOR TO PROCEEDING WITH THE WORK.
- 5. DETAILS ARE INTENDED TO SHOW END RESULT OF DESIGN. MINOR MODIFICATIONS MAY BE REQUIRED TO SUIT JOB DIMENSIONS OR CONDITIONS, AND SUCH MODIFICATIONS SHALL BE INCLUDED AS PART OF THE WORK.
- 6. CONTRACTOR SHALL RECEIVE CLARIFICATION IN WRITING, AND SHALL RECEIVE IN WRITING AUTHORIZATION TO PROCEED BEFORE STARTING WORK ON ANY ITEMS NOT CLEARLY DEFINED OR IDENTIFIED BY THE CONTRACT DOCUMENTS.
- 7. CONTRACTOR SHALL NOTIFY THE CONSTRUCTION MANAGER OF ALL PRODUCTS OR ITEMS NOTED AS "EXISTING" WHICH ARE NOT FOUND TO BE IN THE FIELD.
- 8. CONTRACTOR SHALL SUPERVISE AND DIRECT THE WORK USING THE BEST CONSTRUCTION SKILLS AND ATTENTION. CONTRACTOR SHALL BE SOLELY RESPONSIBLE FOR CONSTRUCTION MEANS, METHODS, TECHNIQUES, SEQUENCES, PROCEDURES, AND FOR COORDINATING ALL PORTIONS OF THE WORK UNDER CONTRACT, UNLESS OTHERWISE NOTED.
- 9. ERECTION SHALL BE DONE IN A WORKMANLIKE MANNER BY COMPETENT EXPERIENCED WORKMEN IN ACCORDANCE WITH APPLICABLE CODES AND THE BEST ACCEPTED PRACTICE. ALL MEMBERS SHALL BE LAID PLUMB AND TRUE AS INDICATED ON THE DRAWINGS.
- 10. CONTRACTOR SHALL BE RESPONSIBLE FOR THE SAFETY OF THE WORK AREA,
 ADJACENT AREAS, AND BUILDING OCCUPANTS THAT ARE LIKELY TO BE AFFECTED BY
 THE WORK UNDER THIS CONTRACT. WORK SHALL CONFORM TO ALL OSHA
 REQUIREMENTS.
- 11. CONTRACTOR SHALL COORDINATE HIS WORK AND SCHEDULE HIS ACTIVITIES AND WORKING HOURS IN ACCORDANCE WITH THE REQUIREMENTS OF THE OWNER.
- 12. CONTRACTOR SHALL BE RESPONSIBLE FOR COORDINATING HIS WORK WITH THE WORK OF OTHERS AS IT MAY RELATE TO RADIO EQUIPMENT, ANTENNAS AND ANY OTHER PORTIONS OF THE WORK.
- 13. CONTRACTOR SHALL MAINTAIN LIABILITY INSURANCE TO PROTECT THE OWNER AND CARRIER.
- 14. INSTALL ALL EQUIPMENT AND MATERIALS IN ACCORDANCE WITH MANUFACTURER'S RECOMMENDATIONS UNLESS SPECIFICALLY INDICATED OR WHERE LOCAL CODES OR REGULATIONS TAKE PRECEDENCE.
- 15. MAKE NECESSARY PROVISIONS TO PROTECT EXISTING SURFACES, EQUIPMENT, IMPROVEMENTS, PIPING, ANTENNA AND ANTENNA CABLES. REPAIR ANY DAMAGE THAT OCCURS DURING CONSTRUCTION.
- 16. REPAIR ALL EXISTING SURFACES DAMAGED DURING CONSTRUCTION SUCH THAT THEY MATCH AND BLEND WITH ADJACENT SURFACES.
- 17. KEEP CONTRACT AREA CLEAN, HAZARD FREE, AND DISPOSE OF ALL DEBRIS AND RUBBISH. EQUIPMENT NOT SPECIFIED AS REMAINING ON THE PROPERTY OF THE OWNER SHALL BE REMOVED. LEAVE PREMISES IN CLEAN CONDITION AND FREE FROM PAINT SPOTS, DUST, OR SMUDGES OF ANY NATURE. CONTRACTOR SHALL BE RESPONSIBLE FOR MAINTAINING ALL ITEMS UNTIL COMPLETION OF CONSTRUCTION.
- 18. CONTRACTOR SHALL VERIFY ALL DIMENSIONS AND CONDITIONS IN THE FIELD PRIOR TO FABRICATION AND ERECTION OF ANY MATERIAL. ANY UNUSUAL CONDITIONS SHALL BE REPORTED TO THE ATTENTION OF THE ENGINEER.
- 19. CONTRACTOR SHALL SECURE ALL NECESSARY BUILDING PERMITS AND INSPECTIONS AND PAY ALL REQUIRED FEES.
- 20. PROVIDE A PORTABLE FIRE EXTINGUISHER WITH A RATING OF NOT LESS THAN 2—A OR 2—A/10—BC WITHIN 75 FEET TRAVEL DISTANCE TO ALL PORTIONS OF THE BUILDOUT AREA DURING CONSTRUCTION.
- 21. ALL BROCHURES, OPERATING AND MAINTENANCE MANUALS, CATALOGS, SHOP DRAWINGS AND OTHER DOCUMENTATION SHALL BE TURNED OVER TO CARRIER AT COMPLETION OF CONSTRUCTION.
- 22. COMPLETE JOB SHALL BE GUARANTEED FOR A PERIOD OF ONE (1) YEAR AFTER THE DATE OF ACCEPTANCE BY CARRIER. ANY WORK, MATERIALS, OR EQUIPMENT FOUND TO BE DEFECTIVE DURING THAT PERIOD SHALL BE CORRECTED IMMEDIATELY UPON WRITTEN NOTIFICATION AT NO ADDITIONAL COST TO CARRIER.
- 23. RIGGING OPERATIONS SHALL BE DONE IN ACCORDANCE WITH STATE AND FEDERAL SAFETY REGULATIONS (OSHA). TECTONIC, CARRIER AND THE OWNER SHALL BE HELD HARMLESS IN THE EVENT THE CONTRACTOR DOES NOT FOLLOW SUCH SAFETY REGULATIONS.
- 24. CONTRACTOR SHALL PROVIDE ACCESS TO THE SITE AND ASSIST THE RADIO EQUIPMENT VENDOR AND THE ANTENNA INSTALLATION CONTRACTOR AS THEY MAY REQUIRE.



1275 JOHN STREET, SUITE 100 WEST HENRIETTA, NY 14586



Project Contact Info
36 British American Blvd.
Suite 101
Latham, NY 12110

WORK ORDER NUMBER

Phone: (518) 783–1630
(800) 829–6531
www.tectonicengineering.com

UPDATED PER 1A

TRR

DATE

 NO.
 DATE
 ISSUE

 0
 5/10/24
 FOR REGULATORY

6/5/24

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ORIGINAL SIZE IN INCHES

SITE INFORMATION

VAN HORNESVILLE FUZE ID#: 17302851 MDG#: 5000921062

PUSKARENKO RD
TOWN OF STARK
HERKIMER COUNTY
NY 13361

SHEET TITLE

GENERAL NOTES

SHEET NUMBER

GN-1

EROSION & SEDIMENT CONTROL MEASURES

TEMPORARY EROSION AND SEDIMENT CONTROL MEASURES

GENERAL MEASURES:

- 1. AS MUCH AS IS PRACTICAL, EXISTING VEGETATION SHALL BE PRESERVED. FOLLOWING THE COMPLETION OF CONSTRUCTION ACTIVITIES IN ANY PORTION OF THE SITE, PERMANENT VEGETATION SHALL BE ESTABLISHED ON ALL EXPOSED SOILS.
- 2. SITE PREPARATION ACTIVITIES SHALL BE PLANNED TO MINIMIZE THE SCOPE AND DURATION OF SOIL DISRUPTION.

PARTICULAR MEASURES:

- 1. DRAINAGE DITCH SEDIMENT FILTERS: UNTIL SUCH TIME AS FINAL SITE STABILIZATION IS COMPLETED, DITCHES SHALL RECEIVE TREATMENT WITH STRAW BALE WEIRS SO AS TO EFFECTIVELY TRAP SEDIMENT AND MINIMIZE ITS RELEASE OFF-SITE. STRAW BALE FILTERS SHALL BE CONSTRUCTED WITHIN EACH DITCH BEGINNING AT ITS DOWNSTREAM TERMINUS AND SHOULD BE PLACED AT INTERVALS OF LESS THAN 50 FEET.
- 2. STRAW BALE BERMS OR SILT FENCES: STRAW BALE BERMS OR SILT FENCES SHALL BE CONSTRUCTED AROUND ALL STOCKPILES OF FILL, TOPSOIL, AND EXCAVATED OVERBURDEN THAT ARE TO REMAIN EXPOSED FOR PERIODS LESS THAN 30 DAYS. STRAW BALE BERMS AND SILT FENCES SHALL BE ANCHORED AND MAINTAINED IN GOOD CONDITION UNTIL SUCH TIME AS SAND STOCKPILES ARE REMOVED AND STOCKPILING AREAS ARE BROUGHT TO FINAL GRADE AND PERMANENTLY STABILIZED.
- 3. TOPSOIL AND FILL THAT IS TO REMAIN STOCKPILED ON-SITE FOR PERIODS GREATER THAN 30 DAYS SHALL BE STABILIZED BY SEEDING. PRIOR TO THE SEEDING OPERATION. THE STOCKPILED MATERIAL SHALL BE GRADED AS NEEDED AND FEASIBLE TO PERMIT THE USE OF CONVENTIONAL EQUIPMENT FOR SEEDBED PREPARATION, SEEDING, MULCH APPLICATION AND MULCH ANCHORING.
- 4. IN NO CASE SHALL ERODIBLE MATERIALS BE STOCKPILED WITHIN 25 FEET OF ANY DITCH, STREAM, OR OTHER SURFACE WATER BODY.

PERMANENT AND TEMPORARY EROSION AND SEDIMENT CONTROL MEASURES

- 1. PERMANENT AND TEMPORARY VEGETATIVE COVER: IMMEDIATELY FOLLOWING THE COMPLETION OF CONSTRUCTION ACTIVITY OR WHERE WORK IS DELAYED AND WILL NOT BE DISTURBED FOR 21 DAYS OR MORE IN ANY PORTION OF THE SITE. PERMANENT OR TEMPORARY VEGETATION SHALL BE ESTABLISHED WITHIN 14 DAYS ON ALL EXPOSED SOILS. ALL DISTURBED AREAS S SHALL BE SEEDED AND MULCHED AS SOON AS PRACTICAL FOLLOWING DISTURBANCE TO STABILIZE BARE SOIL AND PROMOTE THE PROMPT RE-ESTABLISHMENT OF VEGETATION.
- AN ADEQUATE SEEDBED SHALL BE PREPARED BY SCARIFYING, COMPACTED SOIL, AND REMOVING SURFACE DEBRIS AND OBSTACLES.
- LIME SHALL BE APPLIED SUFFICIENTLY TO ATTAIN A SOIL ACIDITY pH OF 6.0 TO 7.0.
- FERTILIZER (5-10-10 MIXTURE OR EQUIVALENT) SHALL BE APPLIED PER SOIL TEST RESULTS OR AT A RATE OF 600 LBS. PER ACRE.
- DISTURBED AREAS WHICH WILL REMAIN TEMPORARILY FALLOW FOR PERIODS GREATER THAN 14 DAYS SHALL BE SEEDED AT THE FOLLOWING RATE TO PRODUCE TEMPORARY GROUND COVER: 30 LBS. RYEGRASS (ANNUAL OR PERENNIAL) PER ACRE. DURING THE WINTER, USE 100 LBS. CERTIFIED "AROOSTOCK" WINTER RYE (CEREAL RYE) PER
- PERMANENT SEEDING SHALL BE APPLIED ON 4" MIN TOPSOIL AT THE FOLLOWING RATE FOR ROUGH OR OCCASIONAL MOWING AREAS: 8 LBS EMPIRE BIRDSFOOT TIREFOIL OR COMMON WHITE CLOVER PER ACRE 20 LBS TALL FESCUE PER ACRE PLUS 2 LBS REDTOP OR 5 LBS RYEGRASS (PERENNIAL) PER ACRE

FOR MOWED AREAS:

- 65 LBS KENTUCKY BLUEGRASS PER ACRE 65 LBS RYEGRASS (PERENNIAL) PER ACRE
- ALL SEEDING SHALL BE PERFORMED USING THE BROADCAST METHOD OR HYDROSEEDING, UNLESS OTHERWISE APPROVED.
- ALL DISTURBED AREAS SHALL BE STABILIZED SUBSEQUENT TO SEEDING BY APPLYING 2 TONS OF STRAW MULCH PER ACRE. STRAW MULCH SHALL BE ANCHORED BY APPLYING 750 LBS OF WOOD FIBER MULCH PER ACRE WITH A HYDROSEEDER, OR TUCKING THE MULCH WITH SMOOTH DISCS OR OTHER MULCH ANCHORING TOOLS TO A DEPTH OF 3" MULCH ANCHORING TOOLS SHALL BE PULLED ACROSS SLOPES ALONG TOPOGRAPHIC
- 2. ALL UNNECESSARY REMOVAL OF HEALTHY TREES SHALL BE AVOIDED. MATERIALS SHALL NOT BE STORED NOR MACHINERY OPERATED WITHIN THE DRIP-LINE OF THE TREES TO REMAIN.

MAINTENANCE OF EROSION AND SEDIMENT CONTROL MEASURES:

- 1. THE CONTRACTOR SHALL ON A DAILY BASIS INSPECT AND MAINTAIN THE INTEGRITY AND FUNCTION OF ALL TEMPORARY EROSION CONTROL MEASURES THROUGHOUT THE DURATION OF THE CONSTRUCTION PROCESS.
- 2. TO ASSURE PROPER FUNCTION, SILTATION BARRIERS SHALL BE MAINTAINED IN GOOD CONDITION AND REINFORCED. EXTENDED. REPAIRED. OR REPLACED AS NECESSARY. WASHOUTS SHALL BE IMMEDIATELY REPAIRED. RE-SEEDED, AND PROTECTED FROM FURTHER EROSION.
- 3. SEDIMENT SHALL BE REMOVED FROM BEHIND THE SEDIMENT FENCE WHEN IT BECOMES ABOUT 0.5 FEET DEEP AT THE FENCE. THE SEDIMENT FENCE SHALL BE REPAIRED AS NECESSARY TO MAINTAIN BARRIER.
- 4. ALL SEEDED AREAS SHALL BE FERTILIZED, RESEEDED AS NECESSARY, AND MULCHED ACCORDING TO SPECIFICATIONS IN THE VEGETATIVE PLAN IN ORDER TO MAINTAIN A VIGOROUS, DENSE VEGETATIVE COVER.

SOIL AND EROSION CONTROL NOTES

- TEMPORARY SEDIMENTATION ENTRAPMENT AREAS SHALL BE PROVIDED AT KEY LOCATIONS TO INTERCEPT AND CLARIFY SILT LADEN RUNOFF FROM THE SITE.
- SILT THAT LEAVES THE SITE IN SPITE OF THE REQUIRED PRECAUTIONS SHALL BE COLLECTED AND REMOVED AS DIRECTED BY APPROPRIATE MUNICIPAL AUTHORITIES.
- AT THE COMPLETION OF THE PROJECT, ALL TEMPORARY SILTATION DEVICES SHALL BE REMOVED AND THE AFFECTED AREAS REGRADED, OR TREATED IN ACCORDANCE WITH THE APPROVED SITE PLANS.
- ALL SEDIMENTATION ENTRAPMENT STRUCTURES WILL BE INSPECTED AND MAINTAINED ON A REGULAR BASIS.
- CONTRACTOR TO INSTALL EROSION CONTROL MEASURES (SILT FENCE AND/OR HAY BALES) AROUND AREAS BEING DISTURBED DURING CONSTRUCTION AND AS NECESSARY.
- 6. CONTRACTOR TO INSTALL SILT FENCE ON DOWN SLOPE OF ALL UTILITY TRENCHES.
- 7.a.DISTANCES SHOWN FROM THE WETLANDS IF ANY ON THE CONSTRUCTION PLANS AND SOIL EROSION AND SEDIMENTATION CONTROL PLANS ESTABLISH THE MINIMUM SEPARATION PERMITTED BETWEEN THE PROPOSED CONSTRUCTION ACTIVITIES AND BOUNDARY OF THE WETLANDS.
- AREA OF DISTURBANCE LINES SHALL BE CLEARLY DELINEATED IN THE FIELD BY INSTALLING b. SNOW FENCE AROUND THE ENTIRE PROPOSED CONSTRUCTION AREA. EXCEPT AS NECESSARY TO PROVIDE MITIGATION PLANTINGS, NO ENCROACHMENT BEYOND THESE LIMITS BY WORKERS OR MACHINERY SHALL BE PERMITTED.
- GRADING AND CLEARING AND OTHER CONSTRUCTION-RELATED ACTIVITIES SHALL TAKE PLACE c.ONLY WITHIN THE DELINEATED AREA OF DISTURBANCE LINES. THESE AREAS OF DISTURBANCE LINES REPRESENT THE MAXIMUM LIMITS OF CONSTRUCTION ACTIVITIES. EVERY ATTEMPT SHALL BE MADE TO FURTHER REDUCE GRADING AND CLEARING ACTIVITIES WITHIN THE AREA OF DISTURBANCE LINES BY MAINTAINING NATURAL VEGETATION AND TOPOGRAPHY WHEREVER
- ALL CONSTRUCTION AND CONSTRUCTION-RELATED ACTIVITIES OCCURRING ON THIS SITE SHALL d.COMPLY WITH STANDARDS AND RECOMMENDATIONS OF THE NEW YORK STANDARDS AND SPECIFICATIONS FOR EROSION AND SEDIMENT CONTROL
- PRIOR TO THE COMMENCEMENT OF ANY SITE WORK, THE APPLICANT SHALL STAKE THE e.LOCATION OF THE CONSTRUCTION ACTIVITY FOR INSPECTION AND APPROVAL BY THE TOWN
- ALL SOIL EROSION AND SEDIMENTATION CONTROL MEASURES SHOWN ON THIS PLAN SHALL BE f. IN PLACE PRIOR TO THE START OF ANY SITE WORK. THE TOWN ENGINEER SHALL HAVE INSPECTED THE INSTALLATION OF ALL REQUIRED SOIL EROSION AND SEDIMENTATION CONTROL MEASURES PRIOR TO THE AUTHORIZATION TO PROCEED WITH ANY PHASE OF THE SITE WORK.
- THROUGHOUT THE CONSTRUCTION PERIOD, A QUALIFIED PROFESSIONAL RETAINED BY THE g. APPLICANT SHALL, ON AT LEAST A WEEKLY BASIS, PRIOR TO ANY PREDICTED RAIN EVENT AND AFTER ANY RUNOFF-PRODUCING RAIN EVENT, INSPECT THE SOIL EROSION AND SEDIMENTATION CONTROL MEASURES TO ENSURE THEIR PROPER FUNCTIONING.
- ALL DRAINAGE STRUCTURES AND ANY OTHER REQUIRED UTILITY APPURTENANCES SHALL BE h.INSTALLED AS REQUIRED BY TOWN SPECIFICATIONS AND AS SHOWN ON THESE PLANS.
- IF THE APPLICANT, DURING THE COURSE OF CONSTRUCTION, ENCOUNTERS SUCH CONDITIONS . AS FLOOD AREAS, UNDERGROUND WATER, SOFT OR SILTY AREAS, IMPROPER DRAINAGE, OR ANY OTHER UNUSUAL CIRCUMSTANCES OR CONDITIONS THAT WERE NOT FORESEEN IN THE ORIGINAL PLANNING, HE SHALL REPORT SUCH CONDITIONS IMMEDIATELY TO THE TOWN ENGINEER. THE APPLICANT MAY SUBMIT, IF HE SO DESIRES, HIS RECOMMENDATIONS AS THE SPECIAL TREATMENT TO BE GIVEN SUCH AREAS TO SECURE ADEQUATE, PERMANENT AND SATISFACTORY CONSTRUCTION. THE TOWN ENGINEER, WITHOUT UNNECESSARY DELAY, SHALL INVESTIGATE THE CONDITION OR CONDITIONS. AND SHALL EITHER APPROVE THE APPLICANT'S RECOMMENDATION TO CORRECT THE CONDITIONS. ORDER A MODIFICATION THEREOF. OR ISSUE HIS OWN SPECIFICATION FOR THE CORRECTION OF THE CONDITIONS. IN THE EVENT OF THE APPLICANT'S DISAGREEMENT WITH THE DECISION OF THE TOWN ENGINEER. OR IN THE EVENT OF A SIGNIFICANT CHANGE RESULTING TO THE SITE PLAN OR ANY CHANGE THAT INVOLVES THE WETLANDS REGULATED AREAS, THE MATTER SHALL BE DECIDED BY THE PLANNING BOARD. ANY SUCH CONDITIONS OBSERVED BY THE PLANNING BOARD OR ITS AGENTS SHALL BE SIMILARLY TREATED.

GROUNDING NOTES

GROUND TESTING AFTER CONSTRUCTION:

- 1. AFTER COMPLETION OF CONSTRUCTION OF THE CELL SITE GROUND SYSTEM, A POST INSTALLATION GROUND TEST SHALL BE PERFORMED BY THE CONTRACTOR. THE CONTRACTOR SHALL DETERMINE THE GROUND RESISTANCE FOR ALL SITES AFTER INSTALLATION OF THE EARTH GROUND SYSTEM. A PRELIMINARY EARTH RESISTIVITY TEST (3 POLE TEST OR CLAMP-ON-METER) SHALL BE PERFORMED PRIOR TO BACK FILLING ALL TRENCHES AS SPECIFIED IN VERIZON NETWORK STANDARDS (NSTD46) AND THE NATIONAL ELECTRIC CODE.
- 2. APPROVED MEASUREMENT METHODS FOR POST INSTALLATION GROUND TESTING SHALL BE ONE OF THE FOLLOWING METHODS:
 - A. FALL OF POTENTIAL METHOD 3 POINT B. CLAMP-ON RESISTANCE TEST
 - C. TOWER AND EXTERNAL CONDUCTOR TEST
- 3. A GROUNDING RESISTANCE TEST REPORT SHALL BE PREPARED UPON COMPLETION OF THE TESTING. THE TEST REPORT SHALL SHOW THE RESISTANCE IN OHMS AT 40%, 52%, 62%, 72% AND 82% POINTS IN 10% INTERVALS. RESISTANCE IS TO BE RECORDED AT EACH INTERVAL FOR EACH POINT FOR FOUR (4) DIFFERENT DIRECTIONS UNTIL THERE IS A PLATEAU SEEN AT THE 62% POINT. TESTING SHOULD BE COMPLETED IN A MINIMUM OF TWO (2) DIFFERENT DIRECTIONS AT 90 DEGREES APART. RECORD THE AVERAGE OR MEAN AS THE RESISTANCE OF THE SITE AND ENTER THIS ON THE POST RESISTANCE DATA CHART.
- 4. PROVIDE THE POST INSTALLATION GROUND RESISTANCE TEST REPORT TO THE REGIONAL PROJECT ENGINEER ACCOMPANIED BY THE POST RESISTANCE DATE CHART.
- 5. ALL LUG CONNECTIONS & THEIR MATING SURFACES MUST BE CLEANED & LIGHTLY COATED WITH NON-OXIDIZING CONDUCTIVE GREASE OR APPROVED ALTERNATIVE COMPOUND. USE OF THE INCORRECT COMPOUND WILL DAMAGE THE LUG CONNECTION. PAINTED SURFACES MUST BE SCRAPED, CLEANED & COATED WITH APPLICABLE NON-OXIDIZING CONDUCTIVE COMPOUNDS. USE OF APPROVED ANTI-OXIDATION COMPOUNDS ON ALL GROUND CONNECTIONS IS REQUIRED. COSMOLINE GREASE BASED COMPOUND (NO OX-ID) IS APPROVED FOR COPPER TO COPPER CONNECTIONS. ZINC BASED (GREY COLORED) COMPOUND IS USED FOR COPPER TO STEEL CONNECTIONS.

ELECTRICAL INSTALLATION NOTES

- 1. ALL ELECTRICAL WORK SHALL BE PERFORMED IN ACCORDANCE WITH THE PROJECT SPECIFICATIONS, NEC AND ALL APPLICABLE LOCAL CODES.
- 2. ALL ELECTRICAL EQUIPMENT AND ACCESSORIES SHALL BE U.L. APPROVED OR LISTED.
- 3. CONDUIT ROUTINGS ARE SCHEMATIC. CONTRACTOR SHALL INSTALL CONDUITS SO THAT ACCESS TO EQUIPMENT IS NOT BLOCKED.
- 4. WIRING, RACEWAY AND SUPPORT METHODS AND MATERIALS SHALL
- COMPLY WITH THE REQUIREMENTS OF THE NEC. 5. ALL CIRCUITS SHALL BE SEGREGATED AND MAINTAIN MINIMUM CABLE
- SEPARATION AS REQUIRED BY THE NEC. 6. CABLES SHALL NOT BE ROUTED THROUGH LADDER-STYLE CABLE TRAY
- 7. EACH END OF EVERY POWER, POWER PHASE CONDUCTOR (I.E., HOTS), GROUNDING, AND T1 CONDUCTOR AND CABLE SHALL BE LABELED WITH COLOR-CODED INSULATION OR ELECTRICAL TAPE (3M BRAND, 1/2 INCH PLASTIC ELECTRICAL TAPE WITH UV PROTECTION, OR EQUAL). THE
- 8. ALL ELECTRICAL COMPONENTS SHALL BE CLEARLY LABELED WITH ENGRAVED LAMACOID PLASTIC LABELS. ALL EQUIPMENT SHALL BE LABELED WITH THEIR VOLTAGE RATING, PHASE CONFIGURATION, WIRE CONFIGURATION, POWER OR AMPACITY RATING, AND BRANCH CIRCUIT ID NUMBERS (I.E., PANELBOARD AND CIRCUIT ID'S).

IDENTIFICATION METHOD SHALL CONFORM WITH NEC & OSHA.

- 9. PANELBOARDS (ID NUMBERS) AND INTERNAL CIRCUIT BREAKERS (CIRCUIT ID NUMBERS) SHALL BE CLEARLY LABELED WITH ENGRAVED LAMACOID PLASTIC LABELS.
- 10. POWER, CONTROL, AND EQUIPMENT GROUND WIRING IN TUBING OR CONDUIT SHALL BE SINGLE CONDUCTOR (#14 AWG OR LARGER), 600 V, OIL RESISTANT THHN OR THWN-2, STRANDED COPPER CABLE RATED FOR 90°C (WET AND DRY) OPERATION; LISTED OR LABELED FOR THE LOCATION AND RACEWAY SYSTEM USED, UNLESS OTHERWISE SPECIFIED.
- 11. SUPPLEMENTAL EQUIPMENT GROUND WIRING LOCATED INDOORS SHALL BE SINGLE CONDUCTOR (#6 AWG OR LARGER), 600 V, OIL RESISTANT THHN OR THWN-2 GREEN INSULATION, STRANDED COPPER CABLE RATED FOR 90°C (WET AND DRY) OPERATION; LISTED OR LABELED FOR THE LOCATION AND RACEWAY SYSTEM USED, UNLESS OTHERWISE SPECIFIED
- 12. POWER AND CONTROL WIRING, NOT IN TUBING OR CONDUIT, SHALL BE MULTI-CONDUCTOR, TYPE USE-2 CABLE (#14 AWG OR LARGER), 600 V, OIL RESISTANT RHW-2 OR XHHW-2, STRANDED COPPER CABLE RATED FOR 90°C (WET AND DRY) OPERATION; WITH OUTER JACKET; LISTED OR LABELED FOR THE LOCATION USED, UNLESS OTHERWISE SPECIFIED.
- 13. ALL POWER AND GROUNDING CONNECTIONS SHALL BE CRIMP-STYLE, COMPRESSION WIRE LUGS AND WIRE NUTS BY THOMAS AND BETTS (OR EQUAL). LUGS AND WIRE NUTS SHALL BE RATED FOR OPERATION AT NO LESS THAN 90°C.
- 14. RACEWAY AND CABLE TRAY SHALL BE LISTED OR LABELED FOR ELECTRICAL USE IN ACCORDANCE WITH NEMA, UL, ANSI/IEEE, AND NEC.
- 15. ELECTRICAL METALLIC TUBING (EMT) OR RIGID METALLIC CONDUIT (RMC) SHALL BE USED FOR EXPOSED INDOOR LOCATIONS.
- 16. ELECTRICAL METALLIC TUBING (EMT) OR RIGID METALLIC CONDUIT (RMC) SHALL BE USED FOR CONCEALED INDOOR LOCATIONS.
- 17. PVC SCHEDULE 40 CONDUIT SHALL BE USED UNDERGROUND EXCEPT IN AREAS OF VEHICULAR TRAFFIC. IN SUCH AREAS, PVC SCHEDULE 80 SHOULD BE USED.

DESIGN AND CONSTRUCTION OF STRUCTURAL STEEL SHALL

CONFORM TO THE AMERICAN INSTITUTE OF STEEL CONSTRUCTION

BUILDING FRAMING", GRADE 50, UNLESS OTHERWISE INDICATED. I

ASTM A572 "HIGH-STRENGTH LOW-ALLOY COLUMBIUM-VANADIUM

3. STEEL PLATES, CHANNELS AND ANGLES SHALL CONFORM TO ASTM

4. ROUND AND SQUARE HOLLOW STRUCTURAL SECTIONS (HSS) SHALL

5. STEEL PIPE SHALL CONFORM TO ASTM A500 "COLD-FORMED

B, OR ASTM A53 "PIPE, STEEL, BLACK AND HOT-DIPPED,

CONFORM TO ASTM A500 "COLD-FORMED WELDED & SEAMLESS

WELDED & SEAMLESS CARBON STEEL STRUCTURAL TUBING", GRADE

ZINC-COATED WELDED AND SEAMLESS", TYPE E OR S, GRADE B

6. ALL STEEL MATERIALS SHALL BE GALVANIZED AFTER FABRICATION

IN ACCORDANCE WITH ASTM A123 "ZINC (HOT-DIP GALVANIZED)

COATINGS ON IRON AND STEEL PRODUCTS", UNLESS OTHERWISE

7. STRUCTURAL CONNECTION BOLTS SHALL BE BOLTS CONFORMING TO

60000 PSI TENSILE STRENGTH", UNLESS OTHERWISE NOTED.

ASTM A307 "CARBON STEEL BOLTS, STUDS, AND THREADED ROD,

MATCHING NUTS SHALL BE HEX TYPE, CONFORMING TO ASTM A563,

THE MEMBER SIZES INDICATED ARE NOT AVAILABLE IN THIS GRADE,

"SPECIFICATION FOR STRUCTURAL STEEL BUILDINGS", LATEST

2. STRUCTURAL STEEL WIDE FLANGE SHAPES SHALL CONFORM TO

ASTM A992. "STEEL FOR STRUCTURAL SHAPES FOR USE IN

STRUCTURAL STEEL", GRADE 50, MAY BE SUBSTITUTED.

CARBON STEEL STRUCTURAL TUBING", GRADE B.

A36 "CARBON STRUCTURAL STEEL".

"CARBON AND ALLOY STEEL NUTS".

STEEL NOTES

EDITION.

NOTED.

- 18. ALL OUTDOOR EXPOSED CONDUIT SHALL BE PVC SCHEDULE 80 AND SHALL BE SUPPORTED ADEQUATELY.
- 19. LIQUID-TIGHT FLEXIBLE METALLIC CONDUIT (LIQUID-TITE FLEX) SHALL BE USED INDOORS AND OUTDOORS, WHERE VIBRATION OCCURS OR FLEXIBILITY IS NEEDED. LFMC SHALL CONFORM TO NEC ARTICLE 350.
- 20. CONDUIT AND TUBING FITTINGS SHALL BE THREADED OR COMPRESSION-TYPE AND APPROVED FOR THE LOCATION USED. SET
- 21. CABINETS, BOXES, AND WIREWAYS SHALL BE LISTED OR LABELED FOR ELECTRICAL USE IN ACCORDANCE WITH NEMA, UL, ANSI/IEEE, AND NEC.

SCREW FITTINGS ARE NOT ACCEPTABLE.

- 22. WIREWAYS SHALL BE EPOXY-COATED (GRAY) AND INCLUDE A HINGED COVER, DESIGNED TO SWING OPEN DOWNWARD; SHALL BE PANDUIT TYPE E (OR EQUAL); AND RATED NEMA 1 (OR BETTER) INDOORS, OR NEMA 3R (OR BETTER) OUTDOORS.
- 23. EQUIPMENT CABINETS, TERMINAL BOXES, JUNCTION BOXES, AND PULL BOXES SHALL BE GALVANIZED OR EPOXY-COATED SHEET STEEL, SHALL MEET OR EXCEED UL 50, AND RATED NEMA 1 (OR BETTER) INDOORS, OR NEMA 3R (OR BETTER) OUTDOORS
- 24. METAL RECEPTACLE, SWITCH, AND DEVICE BOXES SHALL BE GALVANIZED EPOXY-COATED, OR NON-CORRODING; SHALL MEET OR EXCEED UL 514A AND NEMA OS 1; AND RATED NEMA 1 (OR BETTER) INDOORS, OF WEATHER PROTECTED (WP OR BETTER) OUTDOORS.
- 25. NON-METALLIC RECEPTACLE, SWITCH, AND DEVICE BOXES SHALL MEET OR EXCEED NEMA OS 2; AND RATED NEMA 1 (OR BETTER) INDOORS, OR WEATHER PROTECTED (WP OR BETTER) OUTDOORS.
- 26. CONTRACTOR SHALL APPLY FOR ELECTRICAL SERVICE AS SOON AS POSSIBLE AND COORDINATE REQUIREMENTS, SERVICE ROUTING, AND METER SOCKET TYPE WITH LOCAL POWER COMPANY.
- 27. CONTRACTOR SHALL APPLY FOR TELEPHONE SERVICE AS SOON AS POSSIBLE AND COORDINATE REQUIREMENTS AND SERVICE ROUTING WITH TELEPHONE COMPANY.
- 28. CONTRACTOR SHALL OBTAIN ALL PERMITS, PAY PERMIT FEES, AND SCHEDULE INSPECTIONS.
- 29. CONTRACTOR SHALL LABEL ELECTRICAL EQUIPMENT IN ACCORDANCE WITH NEC 110.16 AND 110.24.
- 30. CONTRACTOR SHALL VERIFY THAT THE MAIN BONDING JUMPER AND GROUNDING ELECTRODE CONDUCTOR IS INSTALLED PROPERLY AT SERVICE ENTRANCE.
- 31. CONTRACTOR SHALL SEAL AROUND ALL CONDUIT PENETRATIONS THROUGH WALLS, FLOORS AND ROOFS TO PREVENT MOISTURE PENETRATION OR VERMIN INFESTATIONS.
- 32. WHERE ELECTRICAL POWER IS TO BE SUB-FED FROM AN EXISTING DISTRIBUTION SYSTEM, THE FOLLOWING SHALL APPLY: A. CONTRACTOR SHALL PERFORM LOAD TESTING TO DETERMINE MAXIMUM FEEDER DEMAND PER N.E.C. ARTICLE 220.
- B. CONTRACTOR SHALL VERIFY WHETHER EXISTING FEEDER CAPACITY EXCEEDS VALUE CALCULATED PER N.E.C. ARTICLE 220.
- C. EACH BRANCH CIRCUIT PROTECTIVE DEVICE SHALL HAVE SAME INTERRUPTING RATING AS EQUIPMENT SUPPLYING IT. D. PREFERRED MEANS OF SUPPLY SHALL BE A BRANCH CIRCUIT

PROTECTIVE DEVICE LOCATED IN EXISTING PANEL.

- 36. DURING TRENCH BACK-FILLING FOR EACH UNDERGROUND ELECTRICAL, TELEPHONE, SIGNAL AND COMMUNICATIONS LINE, PROVIDE A CONTINUOUS UNDERGROUND WARNING TAPE TWELVE INCHES BELOW FINISHED GRADE.
- 8. ALL BOLTS, ANCHORS AND MISCELLANEOUS HARDWARE SHALL BE
- (HOT-DIP) ON IRON AND STEEL HARDWARE", UNLESS OTHERWISE

GALVANIZING IN ACCORDANCE WITH ASTM A780.

GALVANIZED IN ACCORDANCE WITH ASTM A153 "ZINC-COATING

10. STRUCTURAL STEEL CONNECTIONS SHALL BE WELDED OR BOLTED.

9. DAMAGED GALVANIZED SURFACES SHALL BE REPAIRED BY COLD

- AS INDICATED: A) CONTRACTOR SHALL COMPLY WITH AWS CODE FOR
- PROCEDURES, APPEARANCE AND QUALITY OF WELDS AND FOR METHODS USED IN CORRECTING WELDING. ALL WELDERS AND WELDING PROCESSES SHALL BE QUALIFIED IN ACCORDANCE WITH AWS "STANDARD QUALIFICATION PROCEDURES".
- B) ALL FILLET WELDS SHALL BE MADE USING THE SHIELDED METAL ARC WELDING (SMAW) PROCESS WITH E70XX ELECTRODES UNLESS OTHERWISE NOTED.
- C) MINIMUM SIZE OF CLIP ANGLES SHALL BE L3x3x3/8" UNLESS OTHERWISE NOTED.
- D) ALL GUSSET PLATES SHALL BE 3/8" THICK UNLESS NOTED.
- E) ALL HOLES FOR BOLTS SHALL BE 1/16 INCH LARGER THAN THE BOLT DIAMETER WITH AN EDGE DISTANCE OF AT LEAST 1 1/2 TIMES THE BOLT DIAMETER AND A SPACING OF AT LEAST 3 TIMES THE BOLT DIAMETER. ALL BOLTS SHALL BE PROVIDED WITH PALNUTS OR LOCK NUTS.
- 11. ALL STEEL PIPE ANTENNA SUPPORTS SHALL BE INSTALLED WITH DOUBLE NUTS SNUG TIGHT.



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UNAUTHORIZED ALTERATION OR ADDITIONS TO A PLAN BEARING THE SEAL OF A LICENSED ENGINEER OR LAND SURVEYOR IS A VIOLATION OF SECTION 7209 SUBDIVISION 2 OF THE NEW YORK STATE EDUCATION

COPIES OF THIS DOCUMENT WITHOUT A FACSIMILE OF THE SIGNATURE AND AN ORIGINAL EMBOSSED SEAL OR ORIGINAL STAMP IN BLUE OR RED INK OF THE PROFESSIONAL ENGINEER OR LAND SURVEYOR SHALL NOT BE CONSIDERED VALID COPIES.

ORIGINAL SIZE IN INCHES SITE INFORMATION

VAN HORNESVILLE | FUZE ID#: 1730285*1* MDG#: 5000921062


SITE ADDRESS

PUSKARENKO RD TOWN OF STARK HERKIMER COUNTY NY 13361

SHEET TITLE

IGENERAL NOTES

SHEET NUMBER

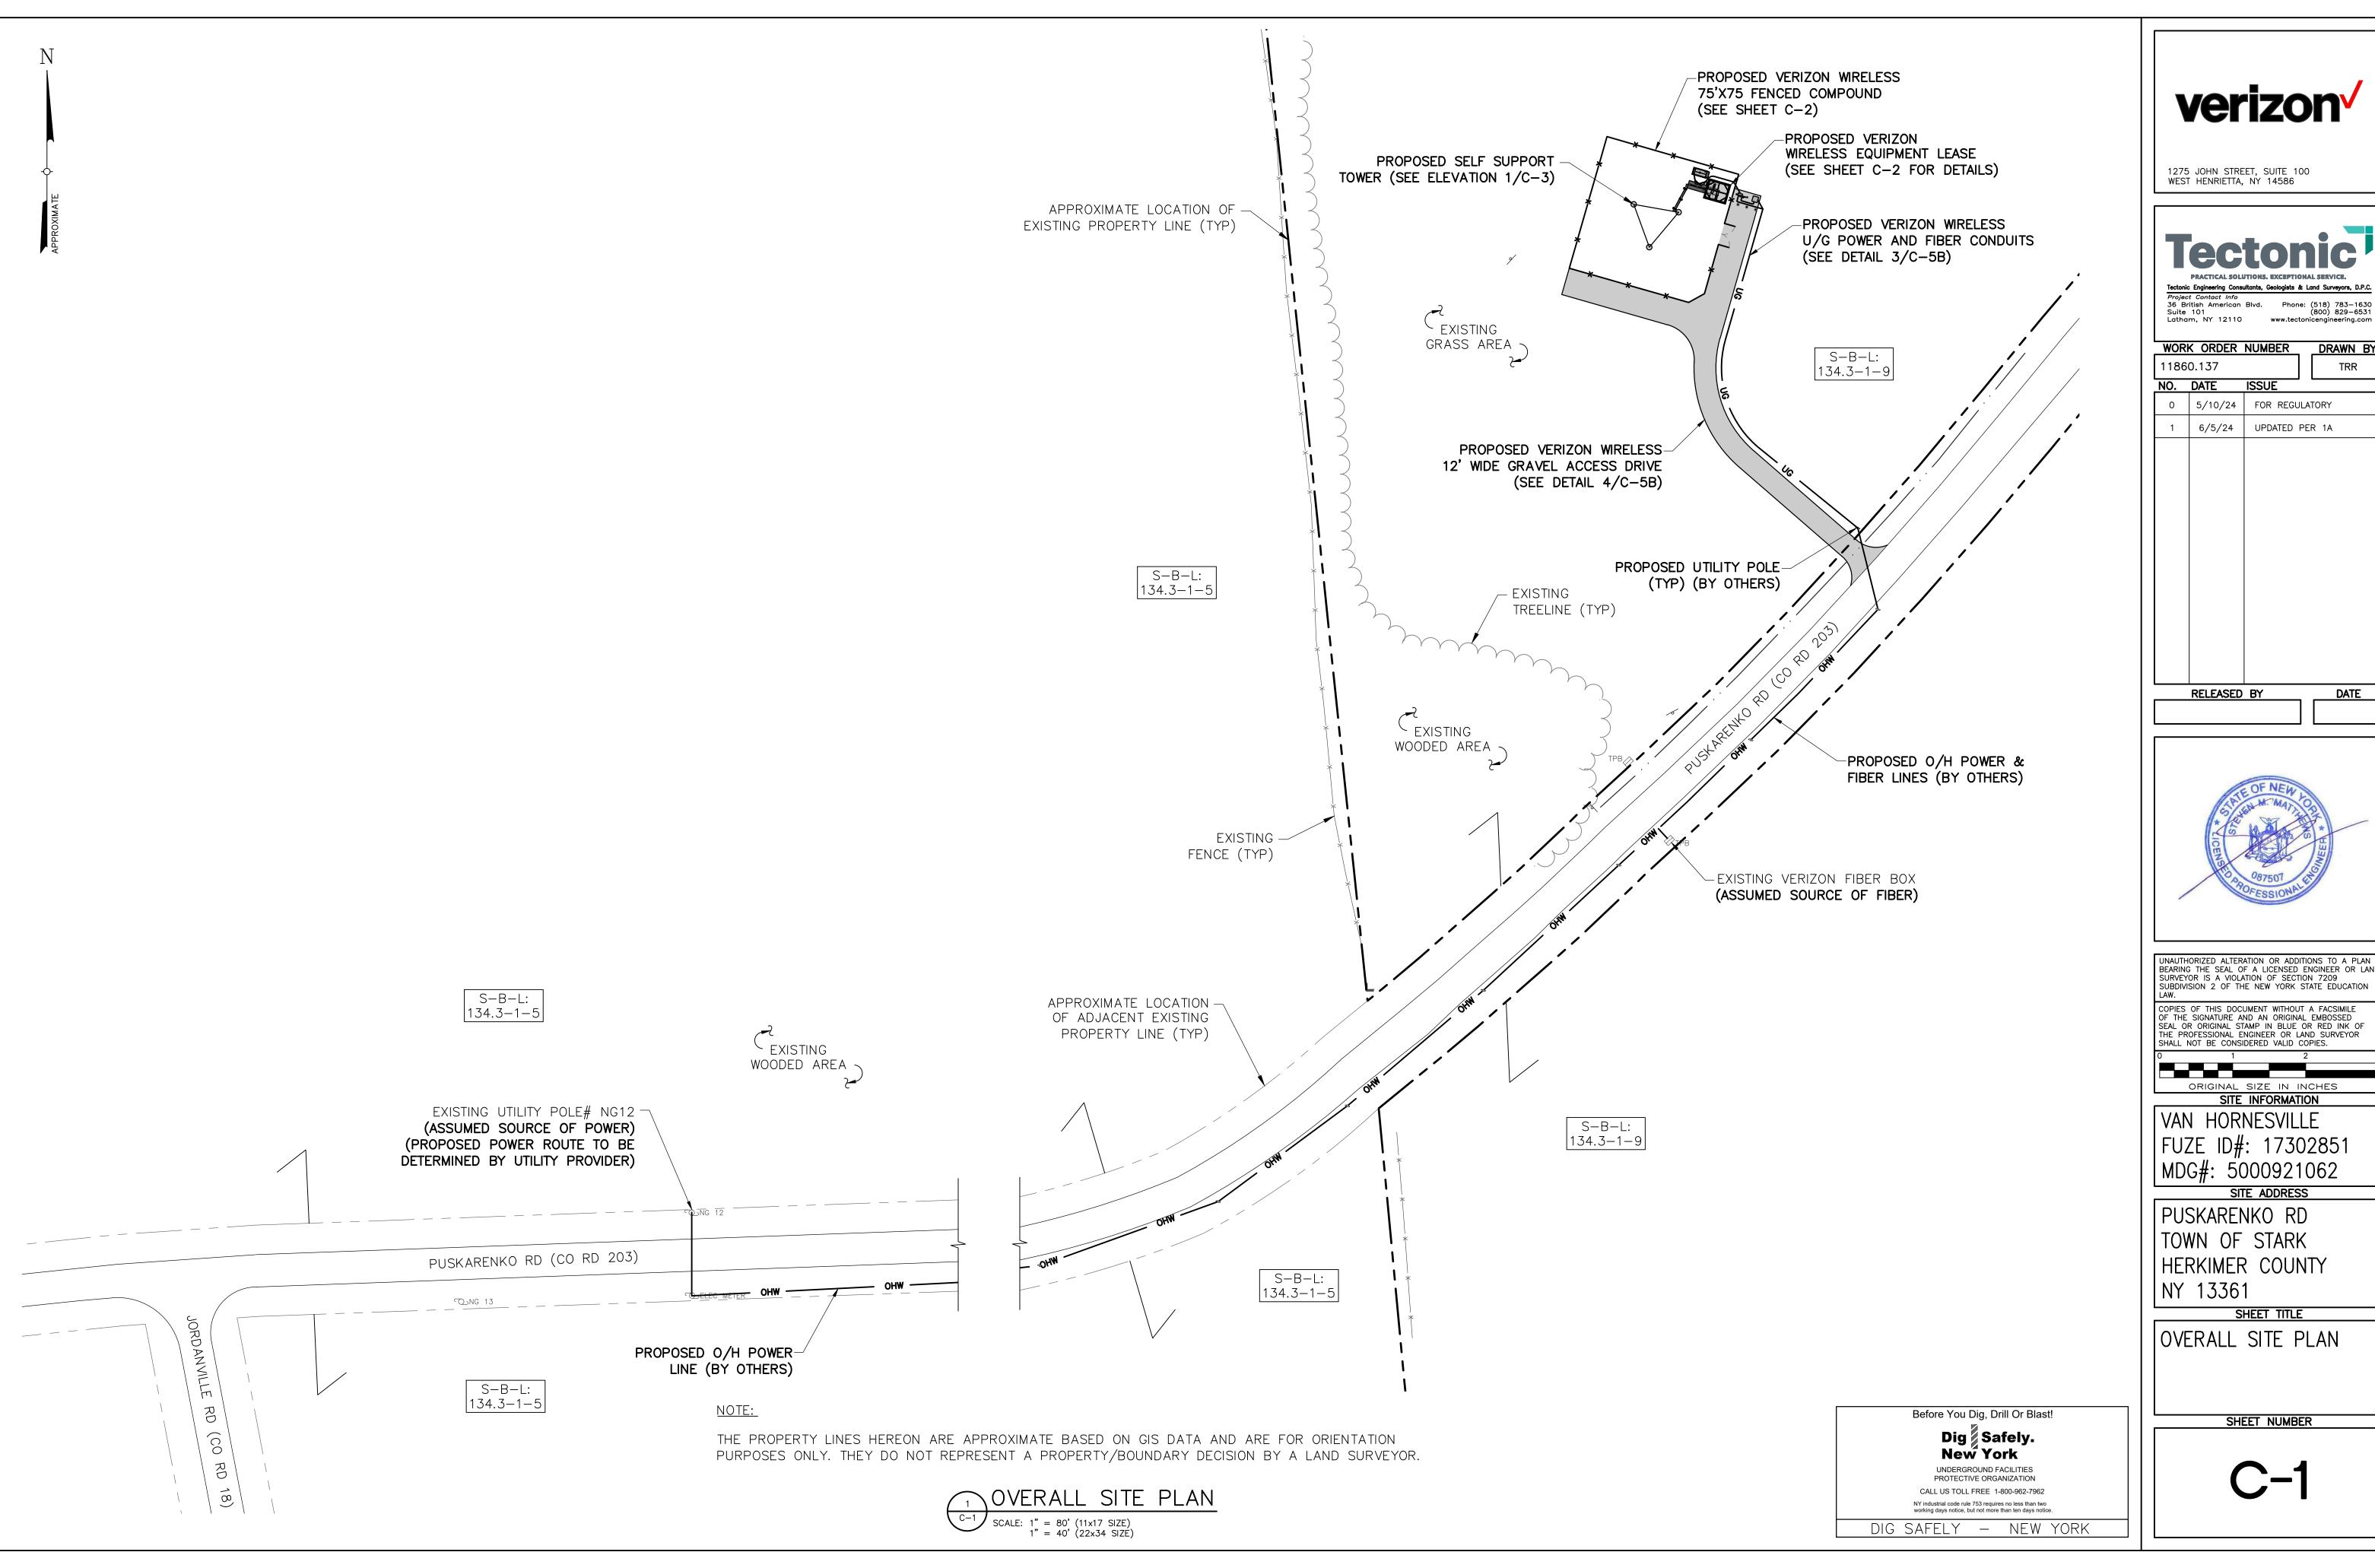






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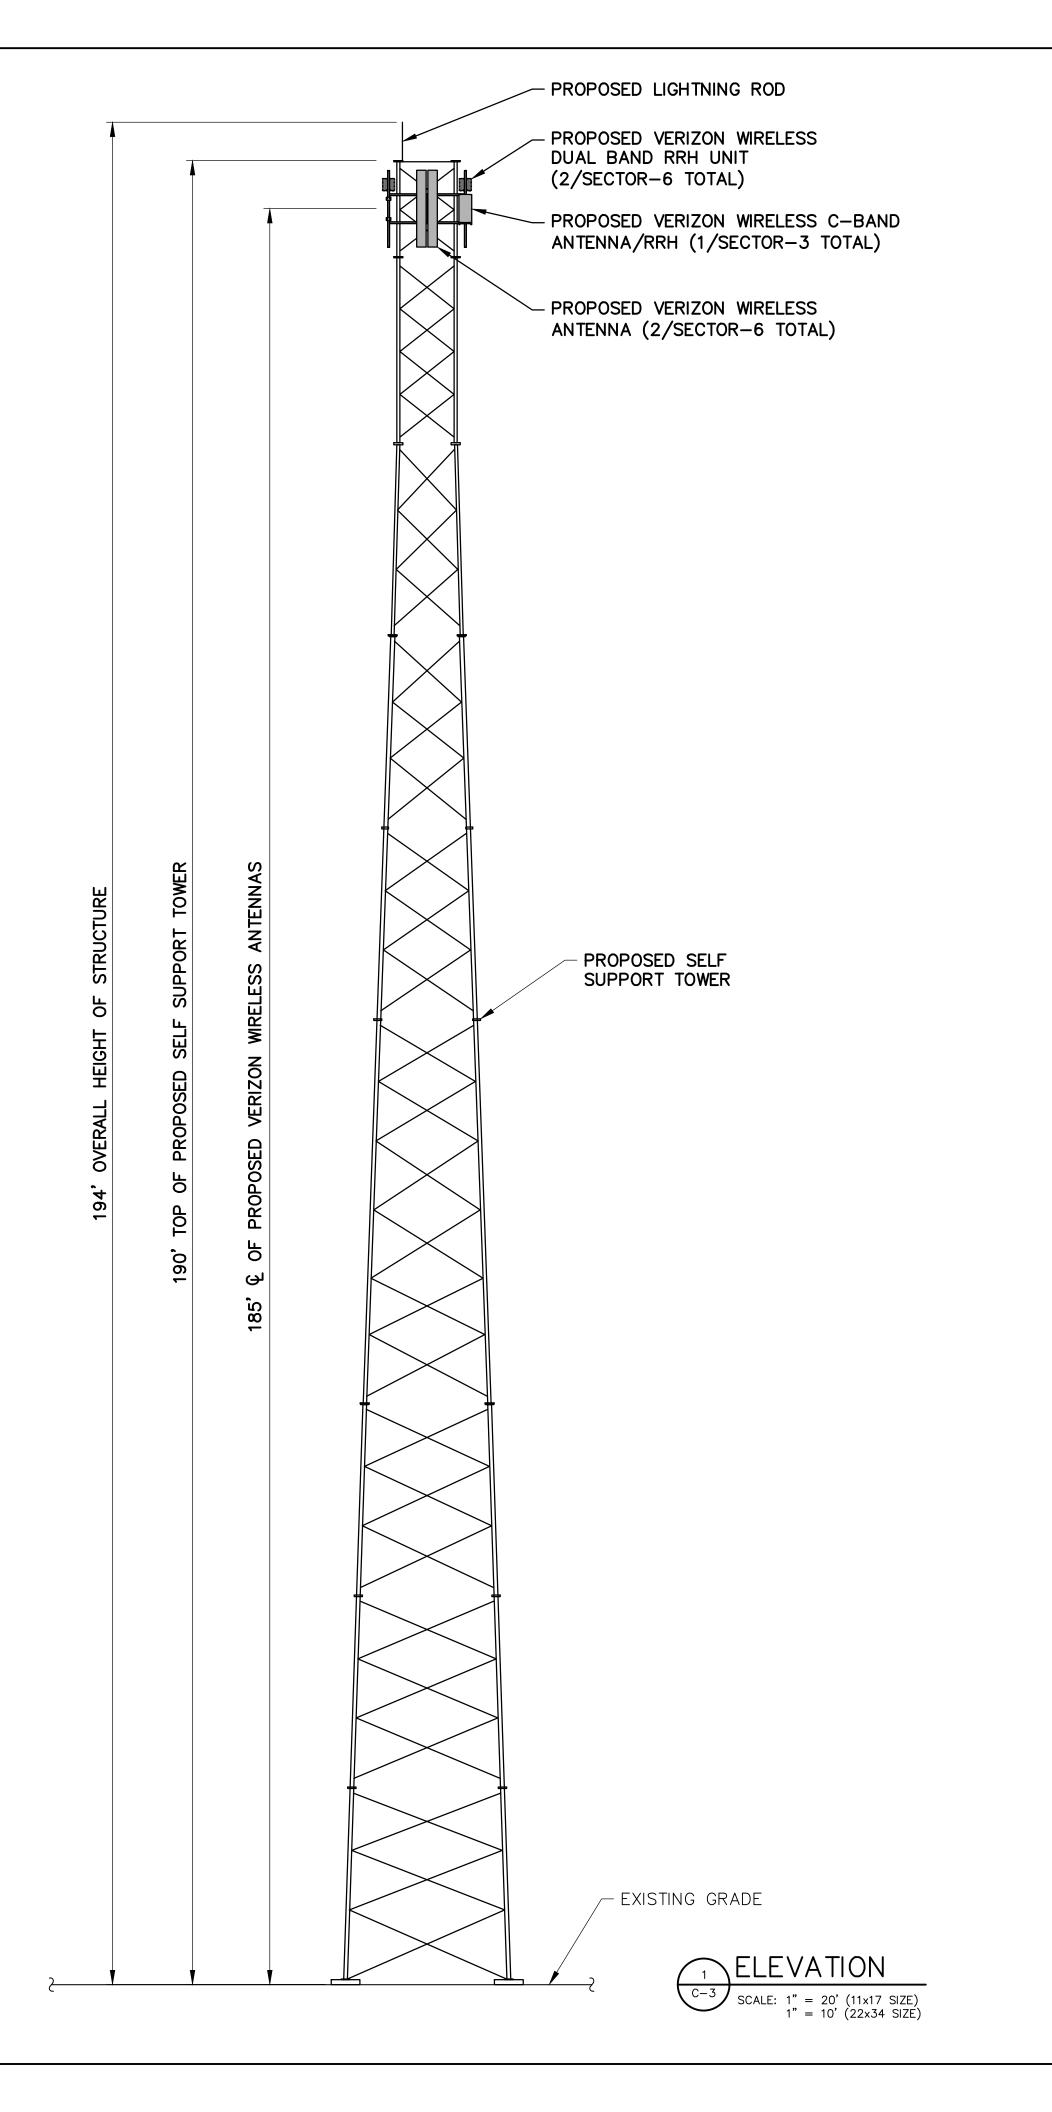
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FUZE ID#: 17302851






NOTE:

ANTENNA AND HYBRID CABLE SCHEDULE BASED ON AN RF ANTENNA DESIGN SHEET DATED 4/15/24, FUZE PROJECT ID 17302851.

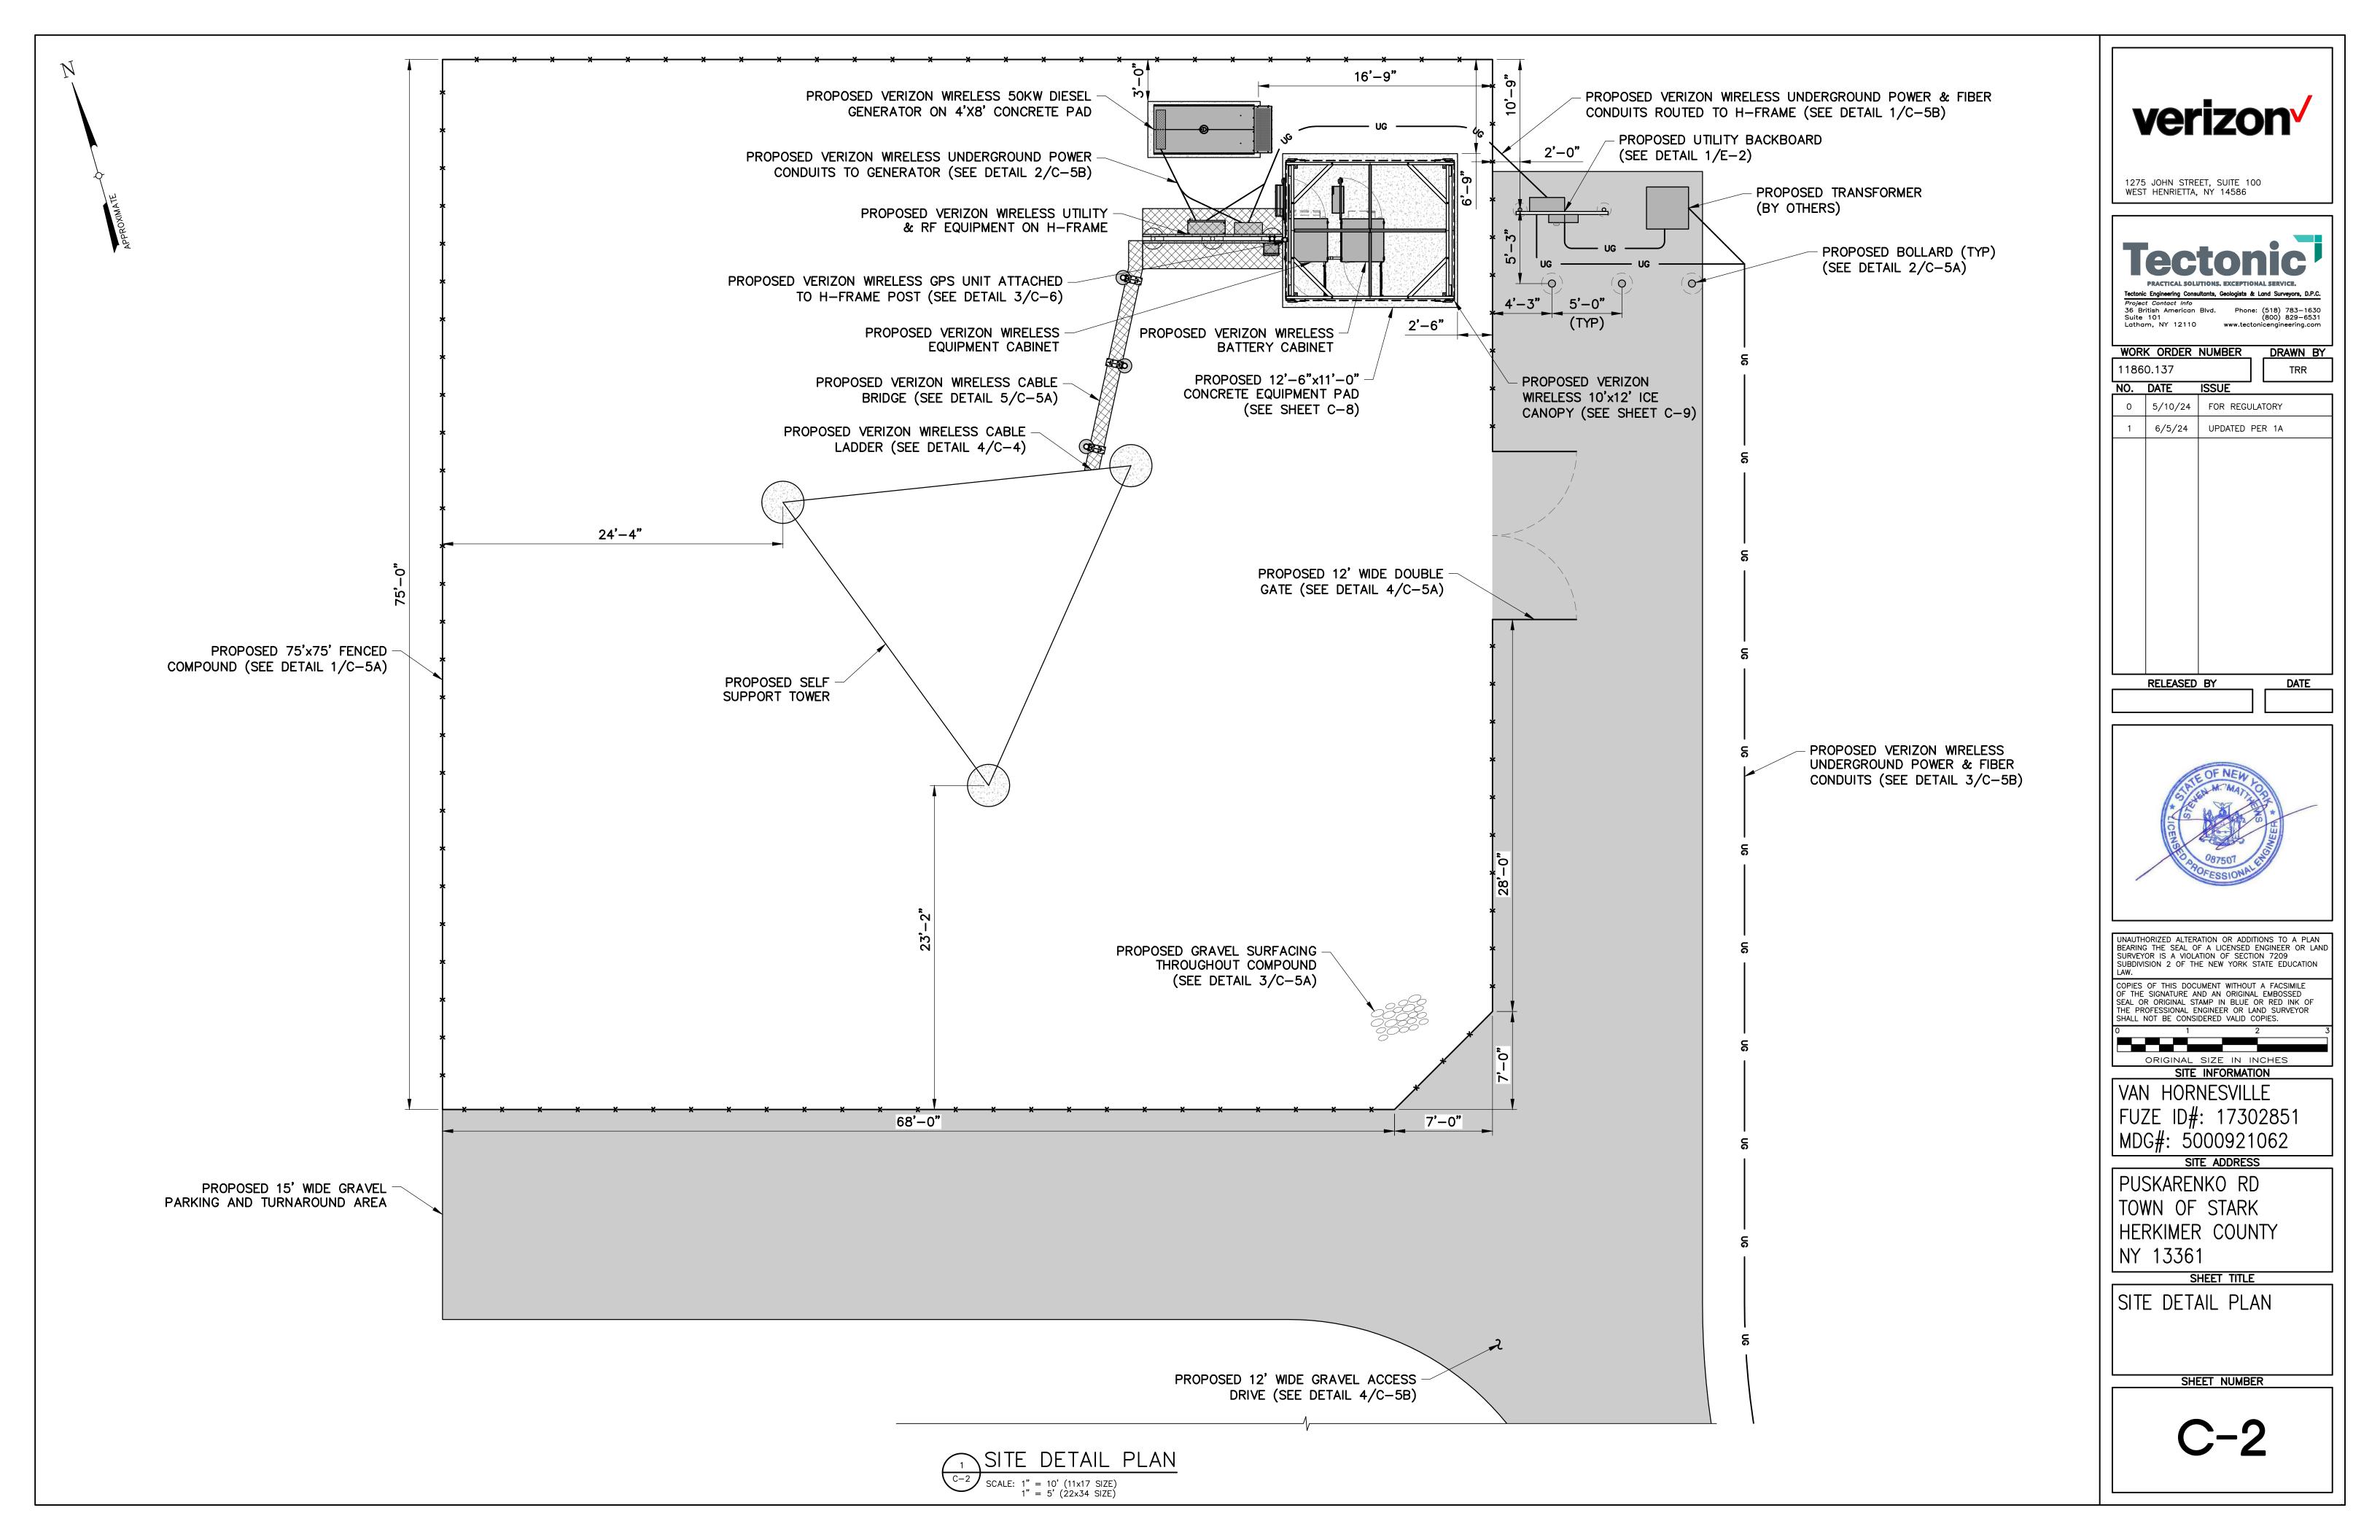ANTENNA AND CABLE SCHEDULE								
SECTOR	STATUS	FREQUENCY	AZIMUTH (TRUE NORTH)	# OF ANTENNAS PER SECTOR	ANTENNA & HEIGHT (AGL)	COAXIAL CABLE	# OF CABLES	CABLE LENGTH
ALPHA	PROPOSED	C-BAND	70°	1	185'	P/F CAE	BLE FROM OVP	15'±
ALPHA	PROPOSED	700/850/PCS	70°	1	185'	JUMPERS	S FROM RRH'S	12'±
ALPHA	PROPOSED	700/850/ AWS	70°	1	185'	JUMPERS	S FROM RRH'S	12'±
ВЕТА	PROPOSED	C-BAND	190°	1	185'	P/F CAE	BLE FROM OVP	25'±
ВЕТА	PROPOSED	700/850/PCS	190°	1	185'	JUMPER	FROM RRH'S	12'±
ВЕТА	PROPOSED	700/850/ AWS	190°	1	185'	JUMPER	FROM RRH'S	12'±
GAMMA	PROPOSED	C-BAND	310°	1	185'	P/F CAE	BLE FROM OVP	25'±
GAMMA	PROPOSED	700/850/PCS	310°	1	185'	JUMPER	FROM RRH'S	12 ' ±
GAMMA	PROPOSED	700/850/ AWS	310°	1	185'	JUMPER	FROM RRH'S	12'±

CONTRACTOR TO TAG HYBRID CABLE & JUMPERS AT BOTH ENDS WITH ANTENNA DESIGNATION AS PER COLOR CODING SHEET PROVIDED BY VERIZON WIRELESS AND AS DIRECTED BY VERIZON WIRELESS EQUIPMENT ENGINEER.

RRH/OVP AND HYBRID SCHEDULE						
SECTOR	TOR STATUS UNITS # OF UNITS CABLE TYPE		# OF CABLES	CABLE LENGTH		
ALPHA	PHA PROPOSED 6627 OVP 1 6X12 HYBRID CABLE		2	230'±		
ALPHA	PROPOSED	700/850 RRH	1	POWER/FIBER CABLE FROM OVP	1	15'±
ALPHA	PROPOSED	AWS/PCS RRH	1	POWER/FIBER CABLE FROM OVP	1	15'±
BETA	PROPOSED	700/850 RRH	1	POWER/FIBER CABLE FROM OVP	1	25'±
BETA	PROPOSED	AWS/PCS RRH	1	POWER/FIBER CABLE FROM OVP	1	25'±
GAMMA	PROPOSED	700/850 RRH	1	POWER/FIBER CABLE FROM OVP	1	25'±
GAMMA	PROPOSED	AWS/PCS RRH	1	POWER/FIBER CABLE FROM OVP	1	25'±

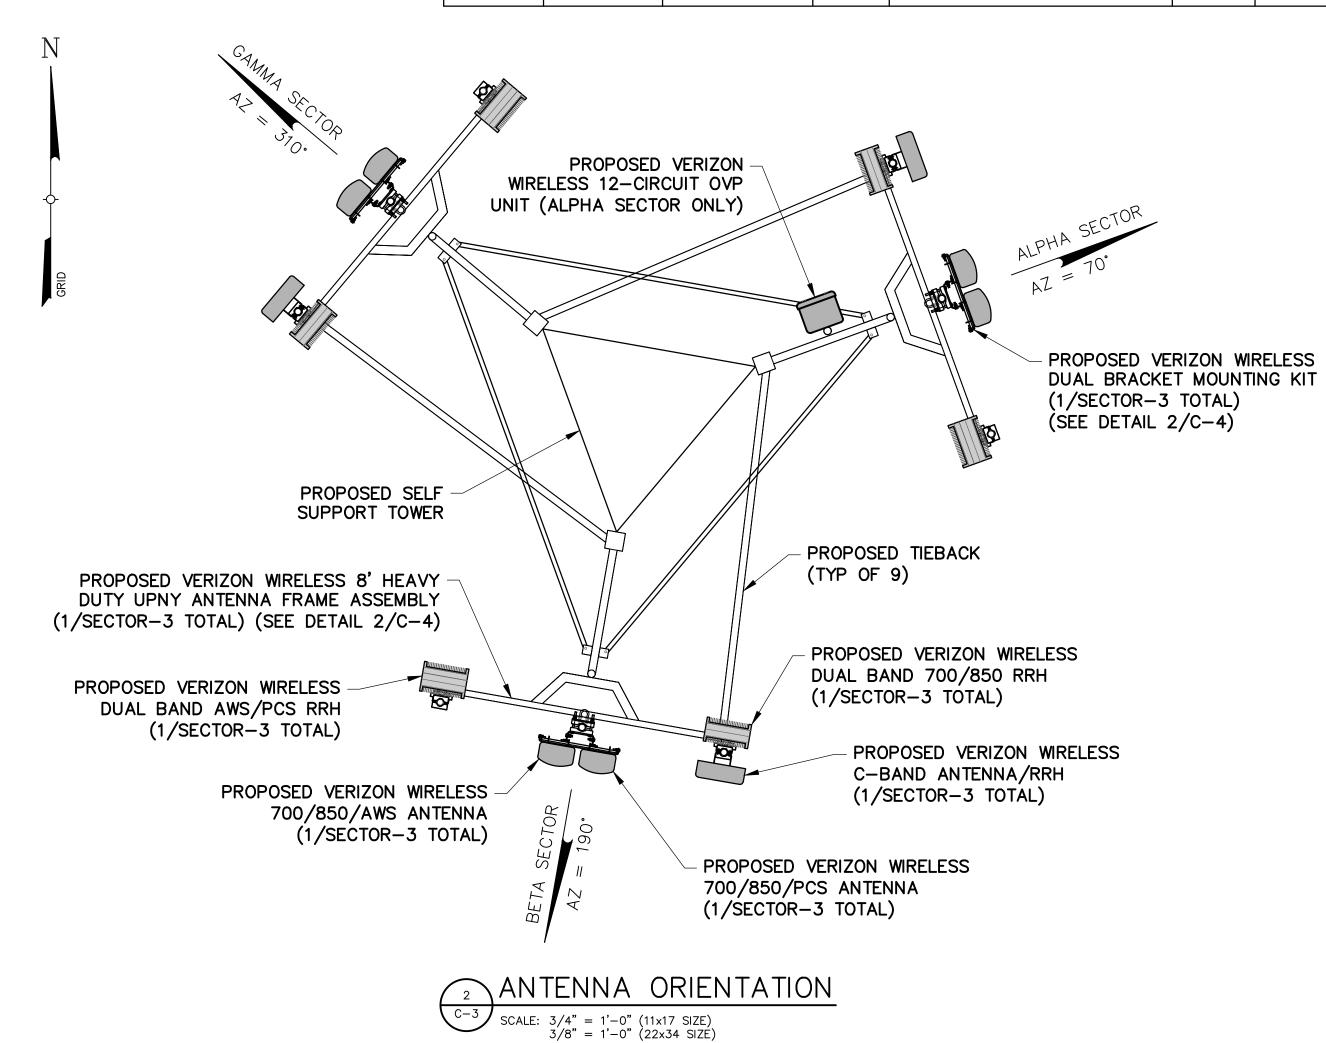



1275 JOHN STREET, SUITE 100 WEST HENRIETTA, NY 14586



Tectonic Engineering Consultants, Geologists & Land Surveyors, D.P.C.

Project Contact Info
36 British American Blvd. Phone: (518) 783-1630
Suite 101 (800) 829-6531
Latham, NY 12110 www.tectonicengineering.com WORK ORDER NUMBER DRAWN BY

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ORIGINAL SIZE IN INCHES
SITE INFORMATION


VAN HORNESVILLE FUZE ID#: 17302851 MDG#: 5000921062


SITE ADDRESS PUSKARENKO RD TOWN OF STARK HERKIMER COUNTY

NY 13361 SHEET TITLE

ELEVATION, ORIENTATION PLAN & RF INFO


SHEET NUMBER

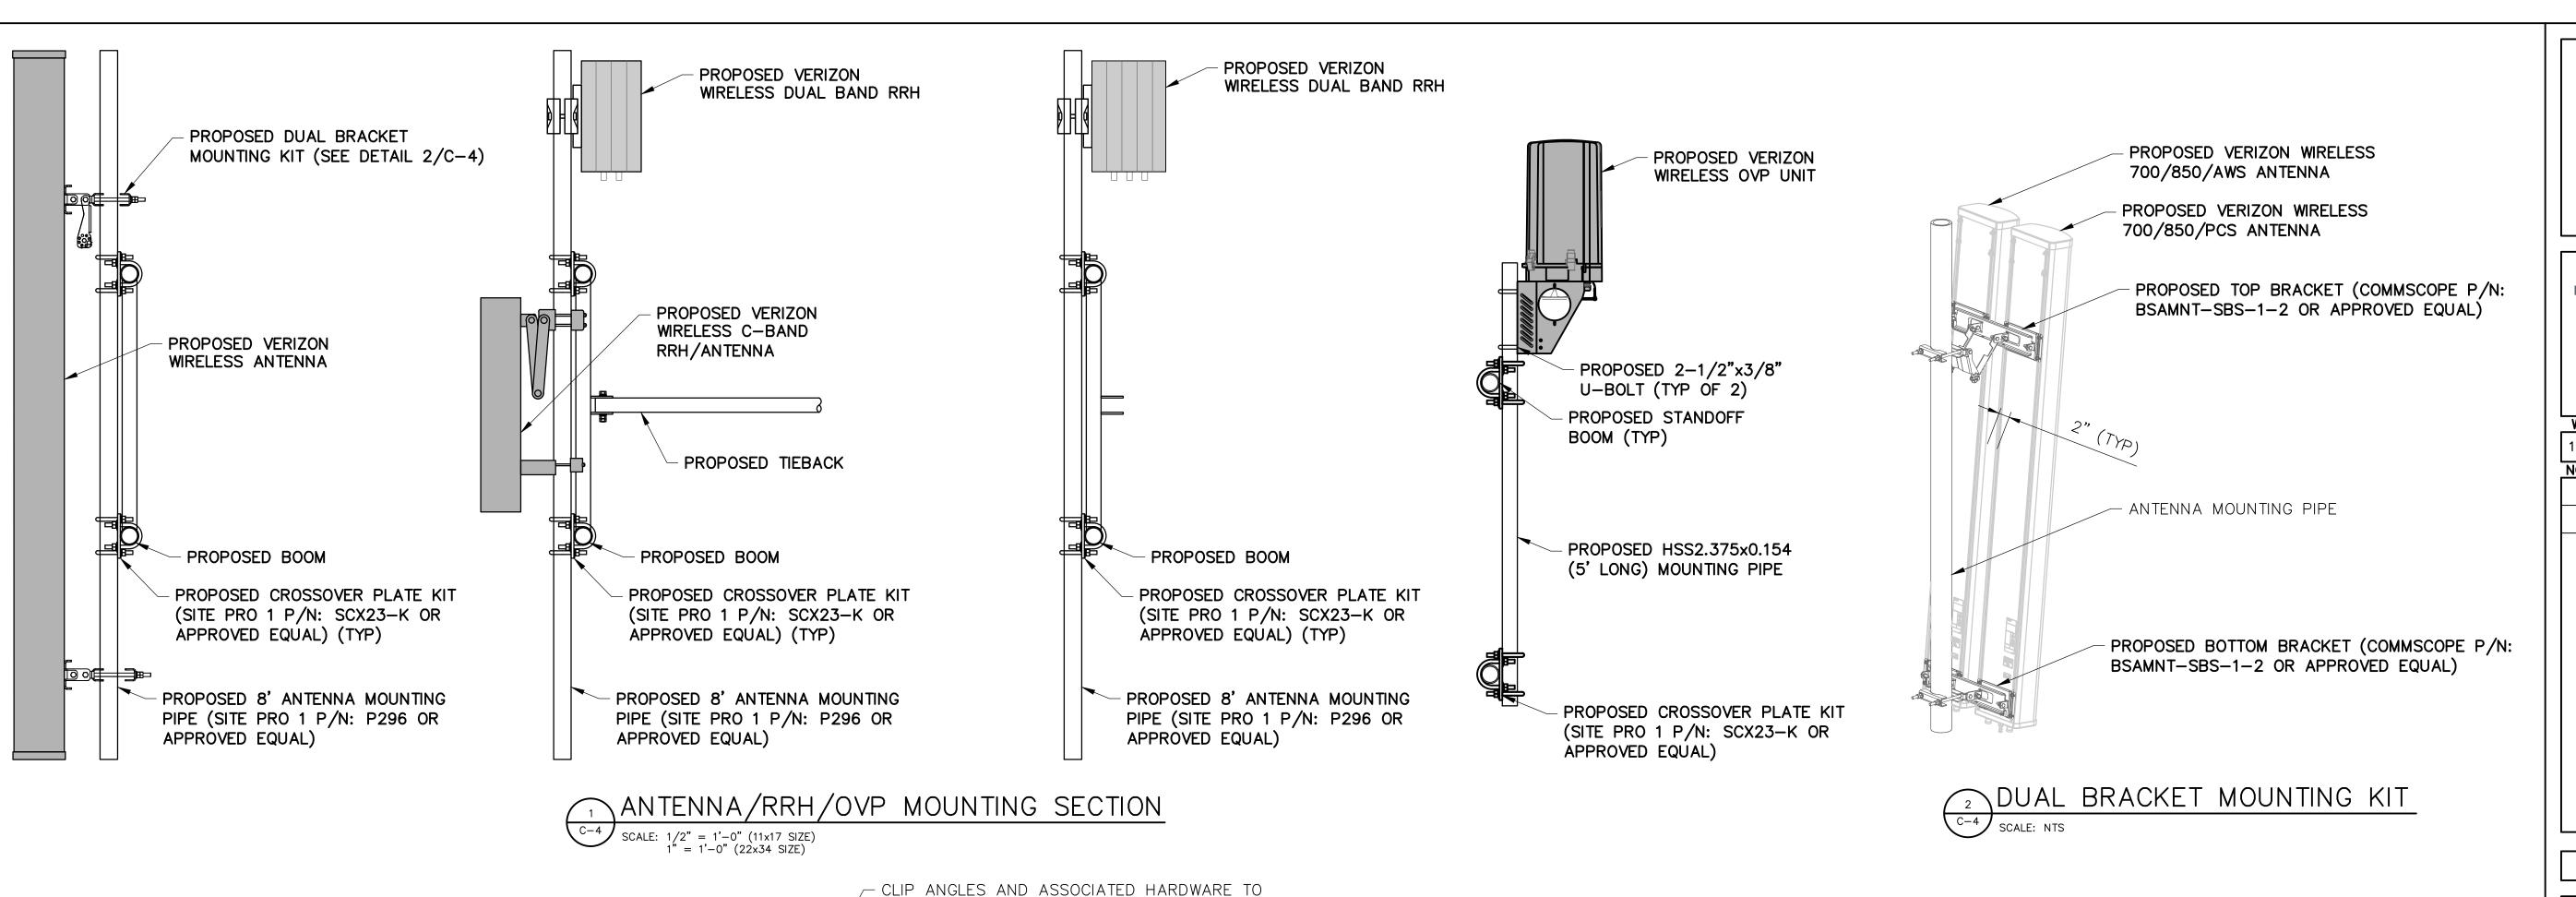

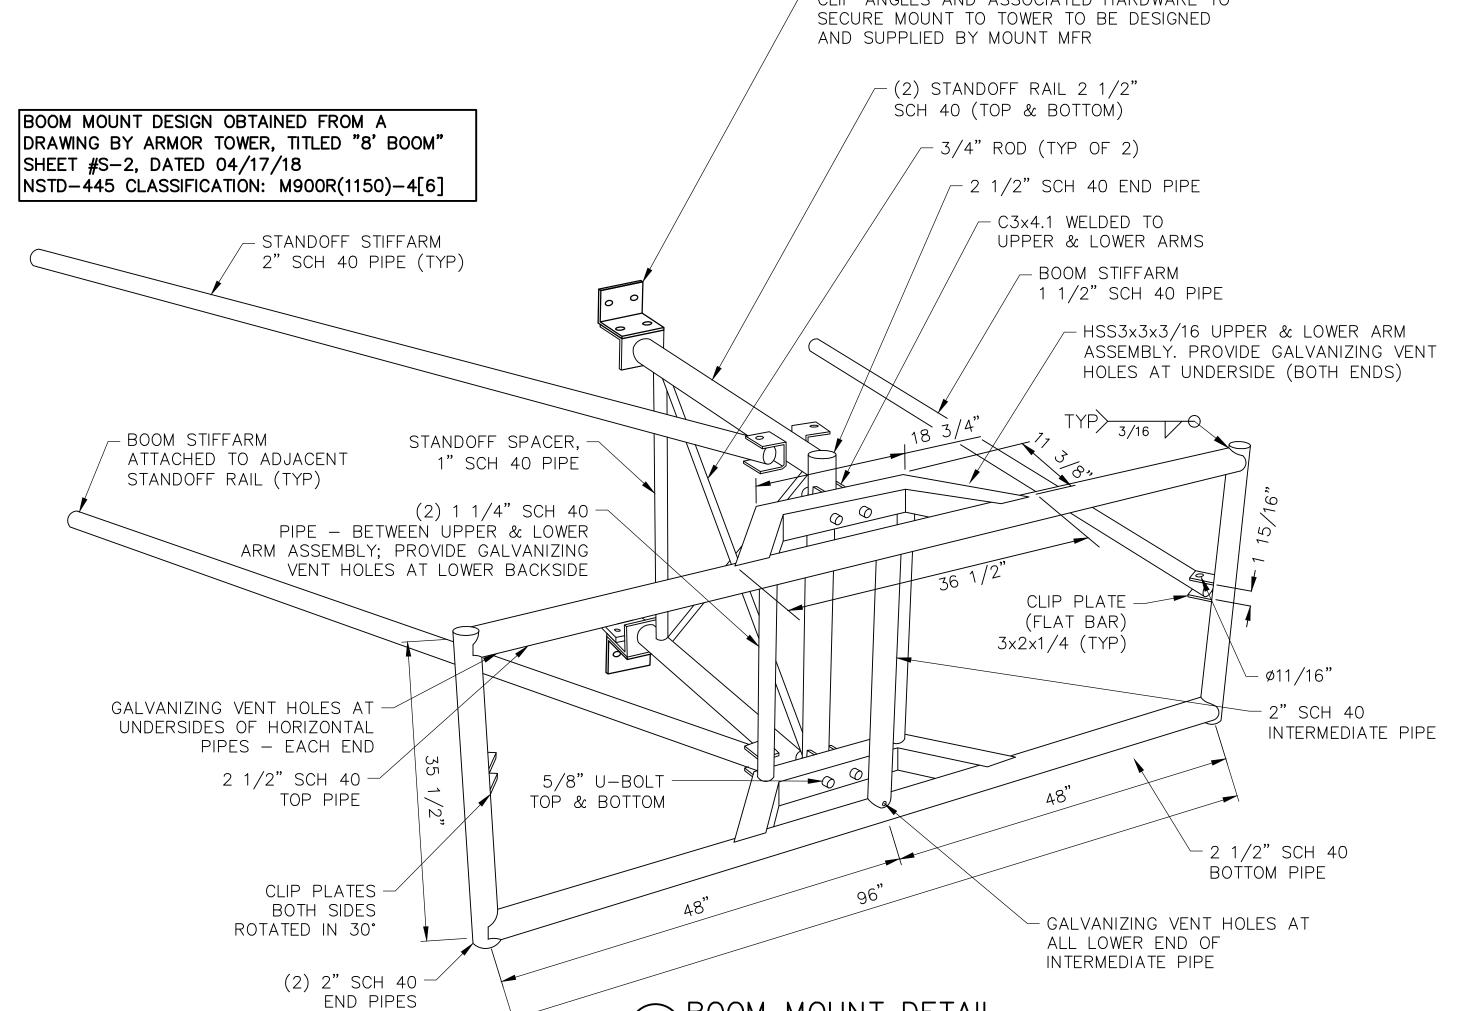

BOOM MOUNT DETAIL

C-4 SCALE: NTS

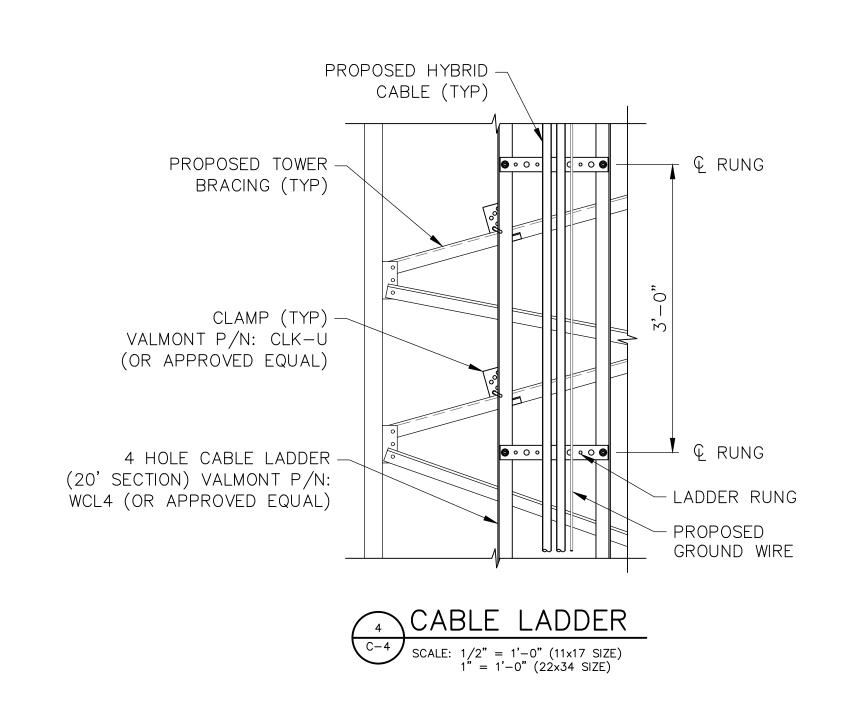



1275 JOHN STREET, SUITE 100 WEST HENRIETTA, NY 14586



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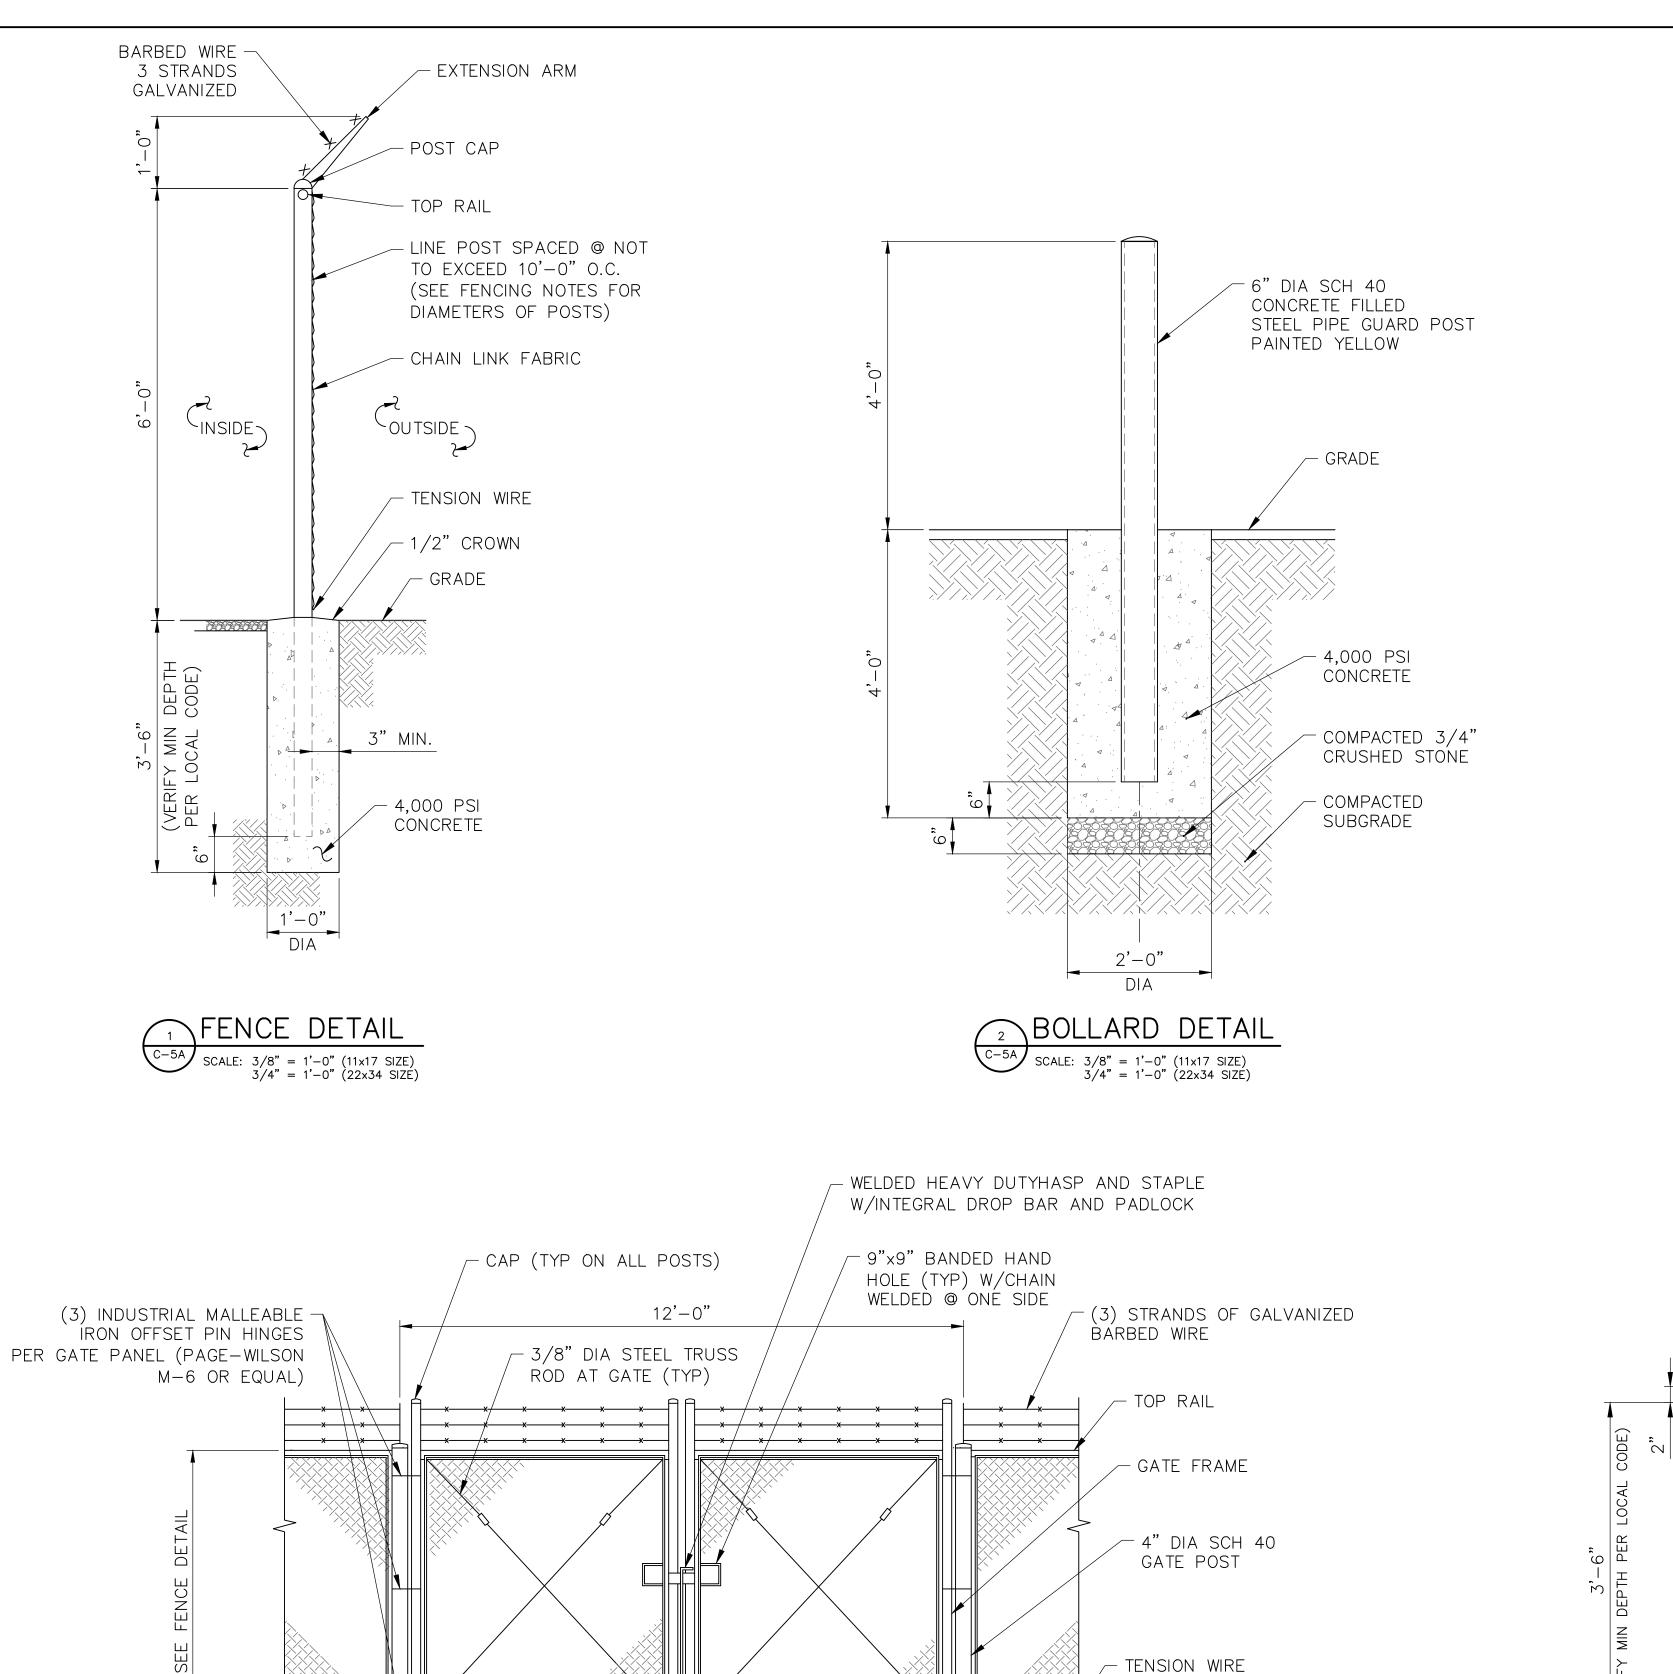
SITE ADDRESS

PUSKARENKO RD
TOWN OF STARK
HERKIMER COUNTY
NY 13361

SHEET TITLE

ANTENNA MOUNTING DETAILS

SHEET NUMBER



CENTER DROP

MUSHROOM CAP

─ SLOTTED

DOUBLE GATE DETAIL


1/2" = 1'-0" (22x34 SIZÉ)


SCALE: 1/4" = 1'-0" (11x17 SIZE)


- GRADE

CONCRETE

(SEE FENCE DETAIL)

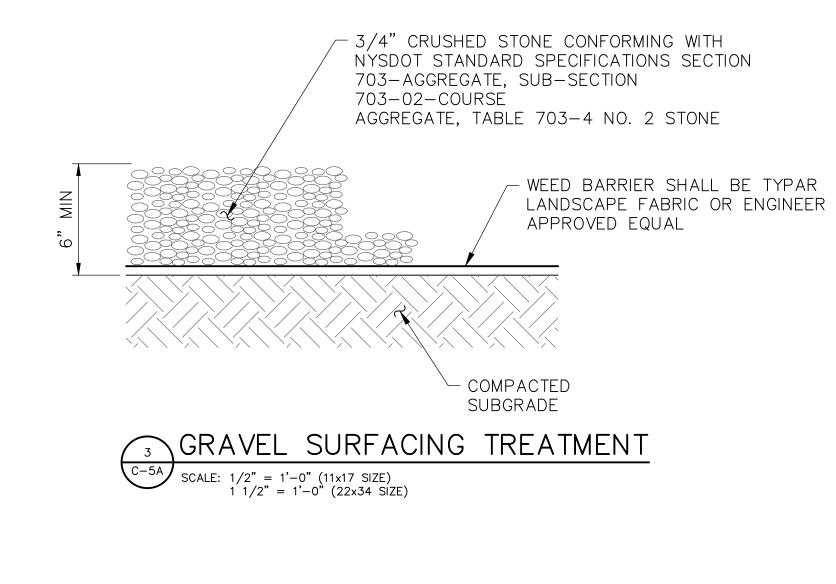

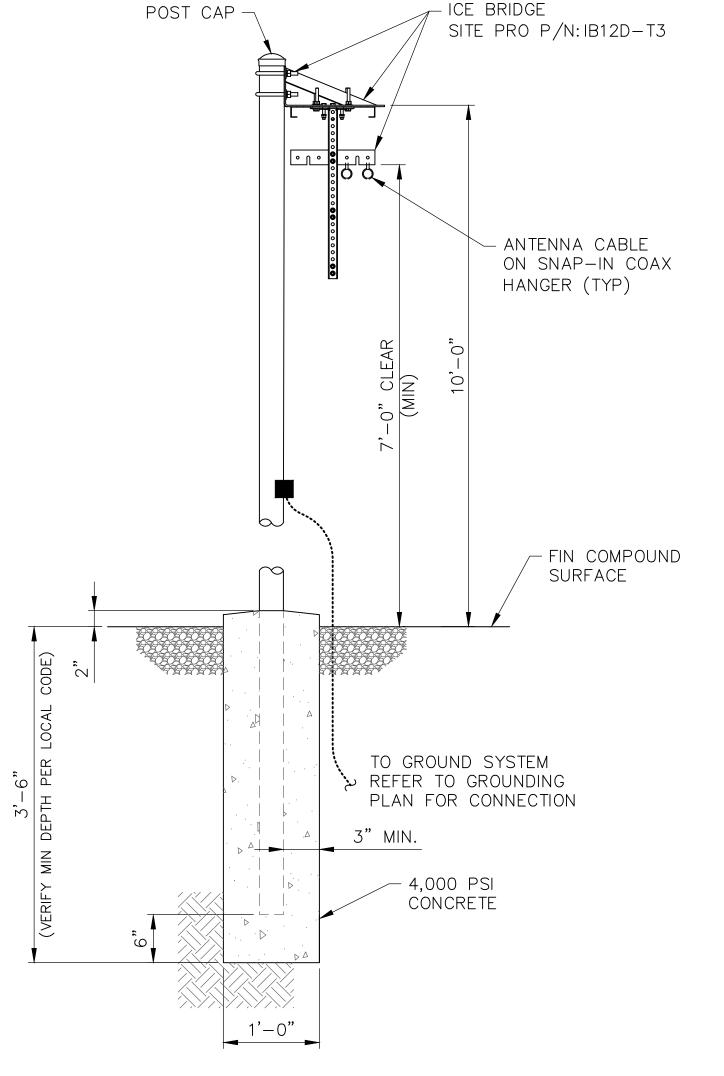

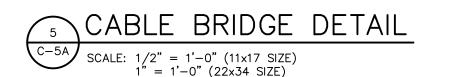



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Tectonic Engineering Consultants, Geologists & Land Surveyors, D.P.C.

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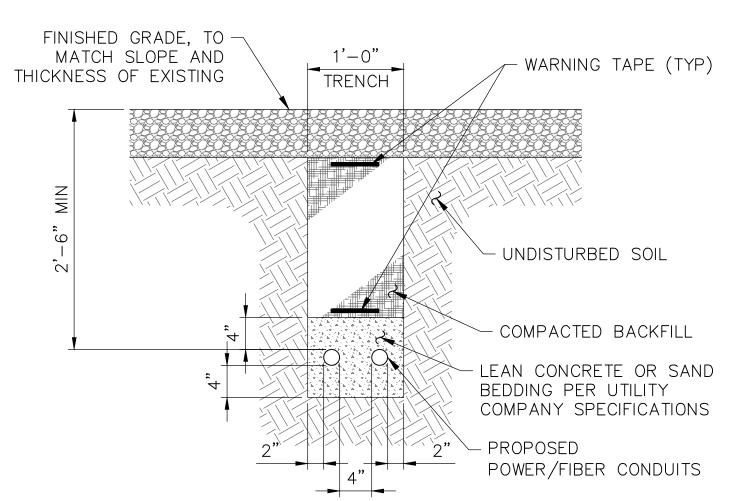
SITE ADDRESS

PUSKARENKO RD TOWN OF STARK HERKIMER COUNTY NY 13361

SHEET TITLE

SITE DETAILS

SHEET NUMBER




NOTES:

1. BACKFILL SHALL BE CLEAN FILL WITHOUT STONES AND SHALL BE THOROUGHLY COMPACTED IN 12" LAYERS BY TAMPING OR APPROVED EQUAL METHOD. NO BELLYING OF TRENCH SHALL BE ALLOWED.

- 2. SCH 40 PVC CONDUIT SHALL BE USED BELOW GRADE.
- 3. SCH 80 PVC CONDUIT SHALL BE USED UNDER ROADWAY.



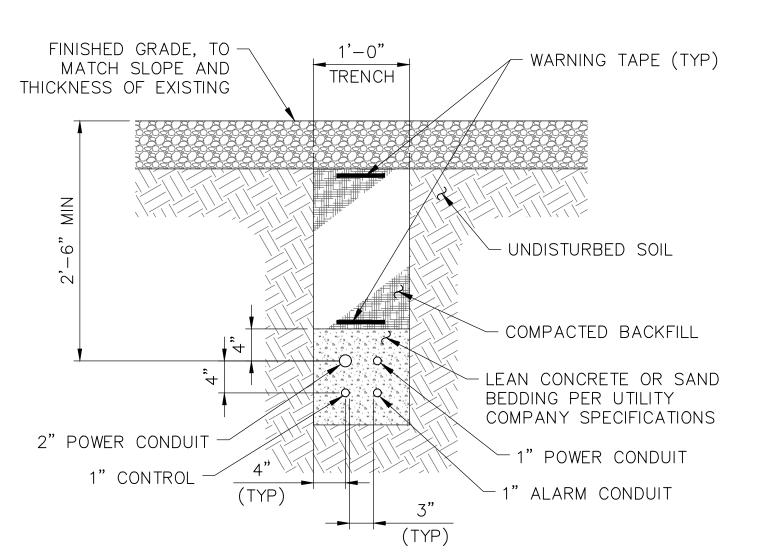


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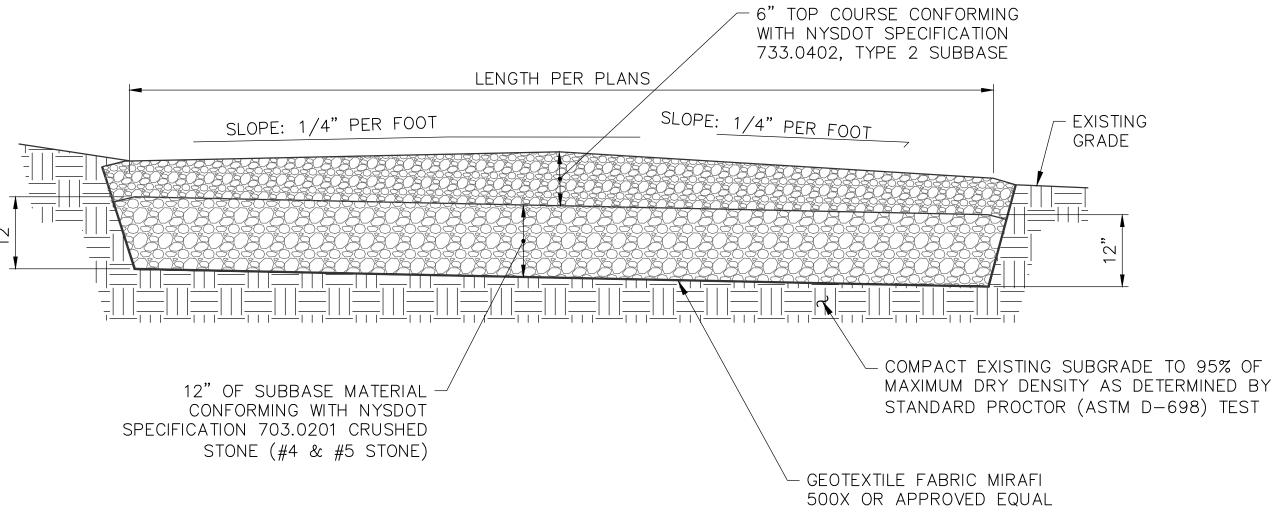




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- 2. SCH 40 PVC CONDUIT SHALL BE USED BELOW GRADE.
- 3. SCH 80 PVC CONDUIT SHALL BE USED UNDER ROADWAY.



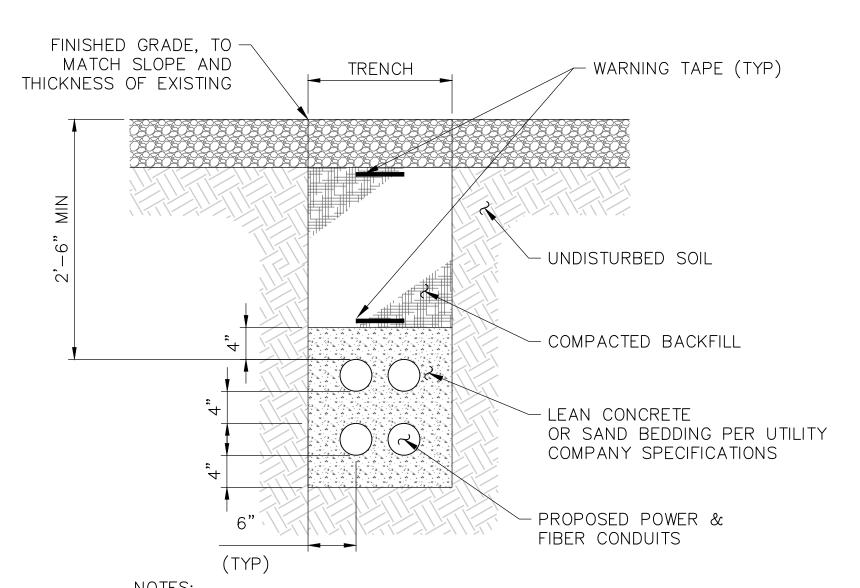

EARTH WORK SUBGRADE COMPACTION & SELECT GRANULAR FILL

- 1. CONTRACTOR SHALL BE RESPONSIBLE FOR CLEARING & GRUBBING THE CONSTRUCTION SITE AND ROADWAY AREAS. THE CONTRACTOR SHALL COMPLY WITH THE RECOMMENDATIONS CONTAINED WITHIN THE GEOTECHNICAL REPORT, AS PREPARED FOR THIS SITE, WHEN NECESSARY, FOR SITE WORK PREPARATION, & FOUNDATION WORK. AS A MINIMUM THE TOP 3" OF GRADE SHALL BE REMOVED, THE EXPOSED SUBGRADE COMPACTED AND GEOTEXTILE FABRIC INSTALLED AS REQUIRED FOR UNSTABLE SOIL CONDITION.
- 2. ALL SELECT GRANULAR FILL SHALL BE COMPACTED TO A 95% COMPACTION AT A MAXIMUM DRY DENSITY AS DETERMINED BY MODIFIED PROCTOR TEST (ASTM D-1557) AND WITHIN PLUS OR MINUS 3% OF OPTIMUM MOISTURE CONTENT.
- 3. CONTRACTOR TO ASSURE THAT EXISTING DRAINAGE PATTERNS ARE MAINTAINED.





1275 JOHN STREET, SUITE 100 WEST HENRIETTA, NY 14586



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ORIGINAL SIZE IN INCHES

SITE INFORMATION

VAN HORNESVILLE FUZE ID#: 17302851 MDG#: 5000921062

PUSKARENKO RD
TOWN OF STARK
HERKIMER COUNTY


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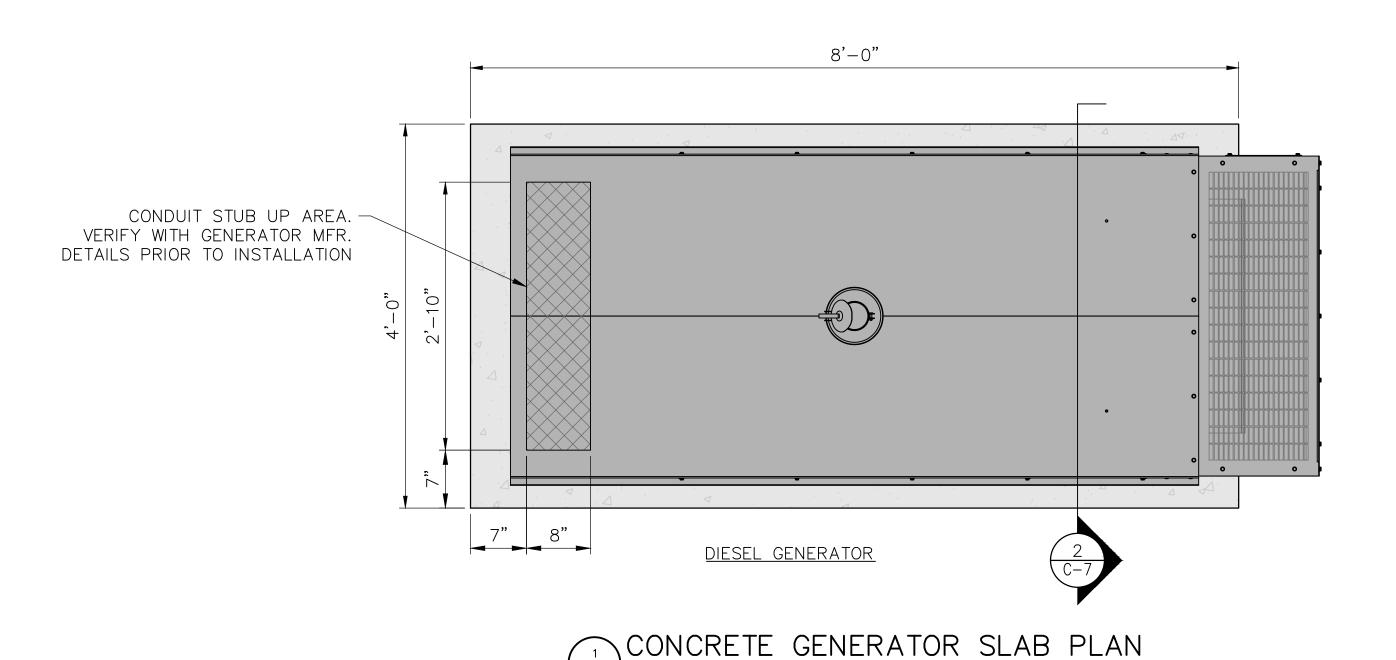
SITE DETAILS

NY 13361


SHEET NUMBER

C-5B



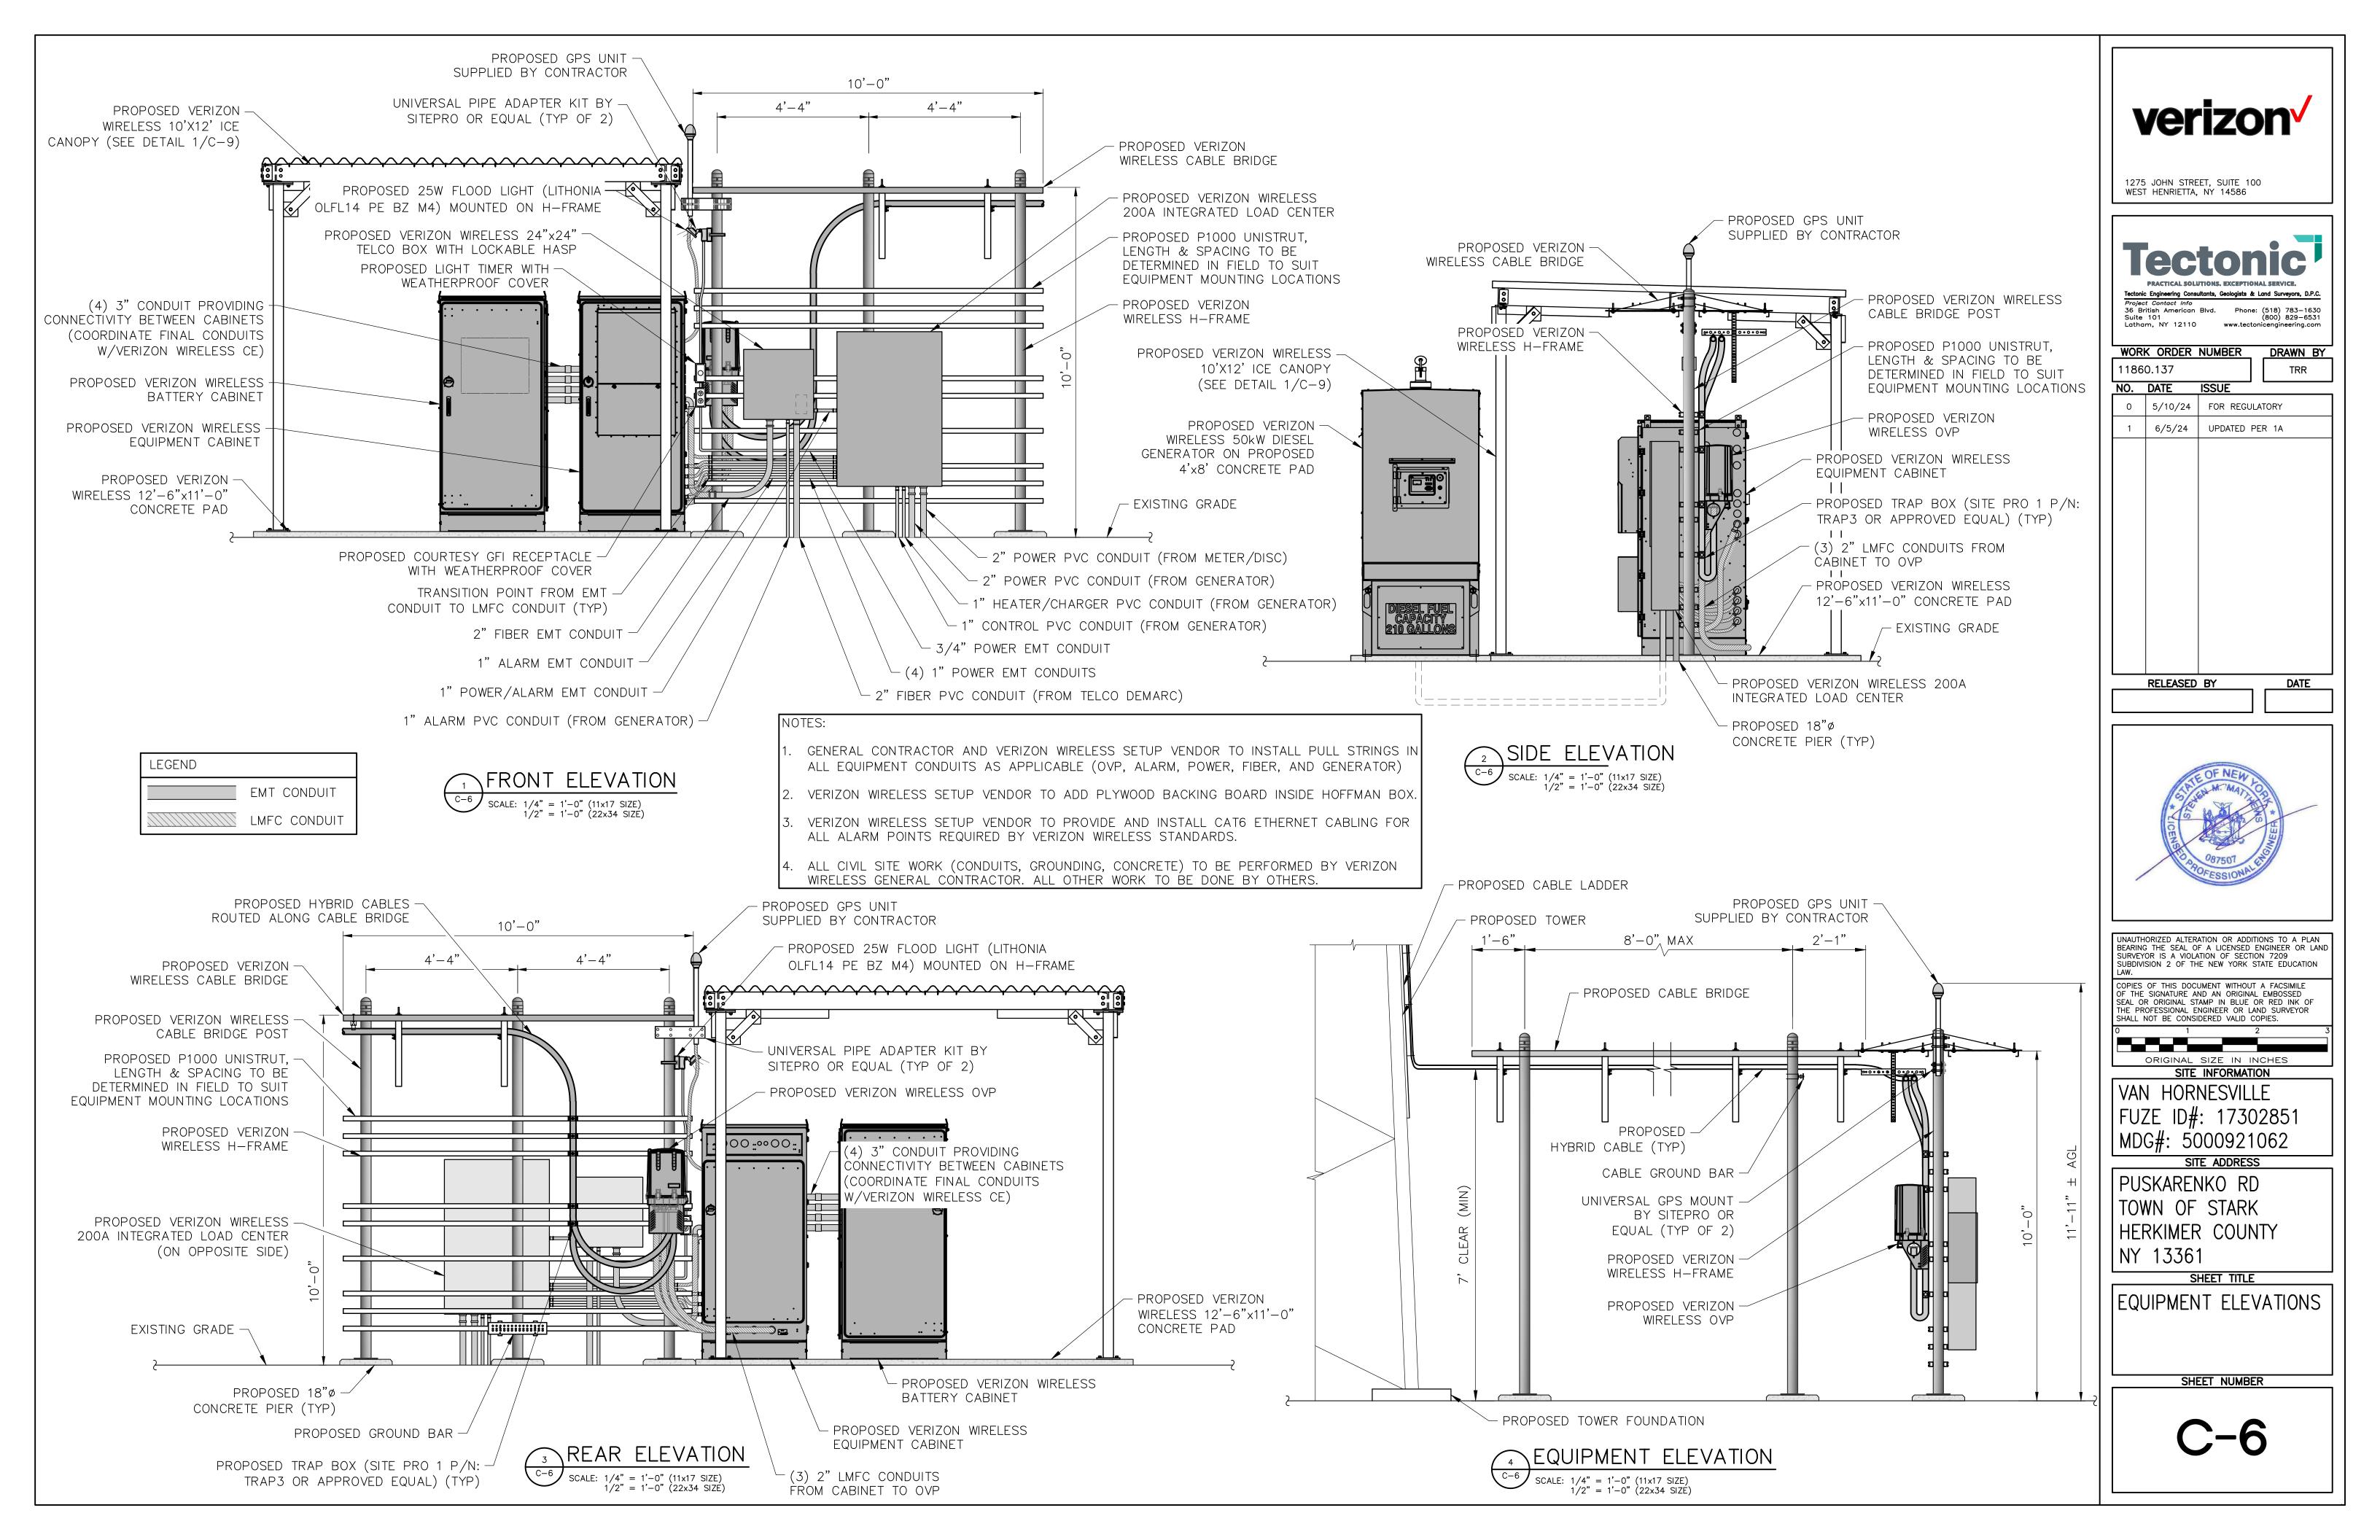

SCALE: 1" = 2" (11x17 SIZE) 1" = 1" (22x34 SIZE)

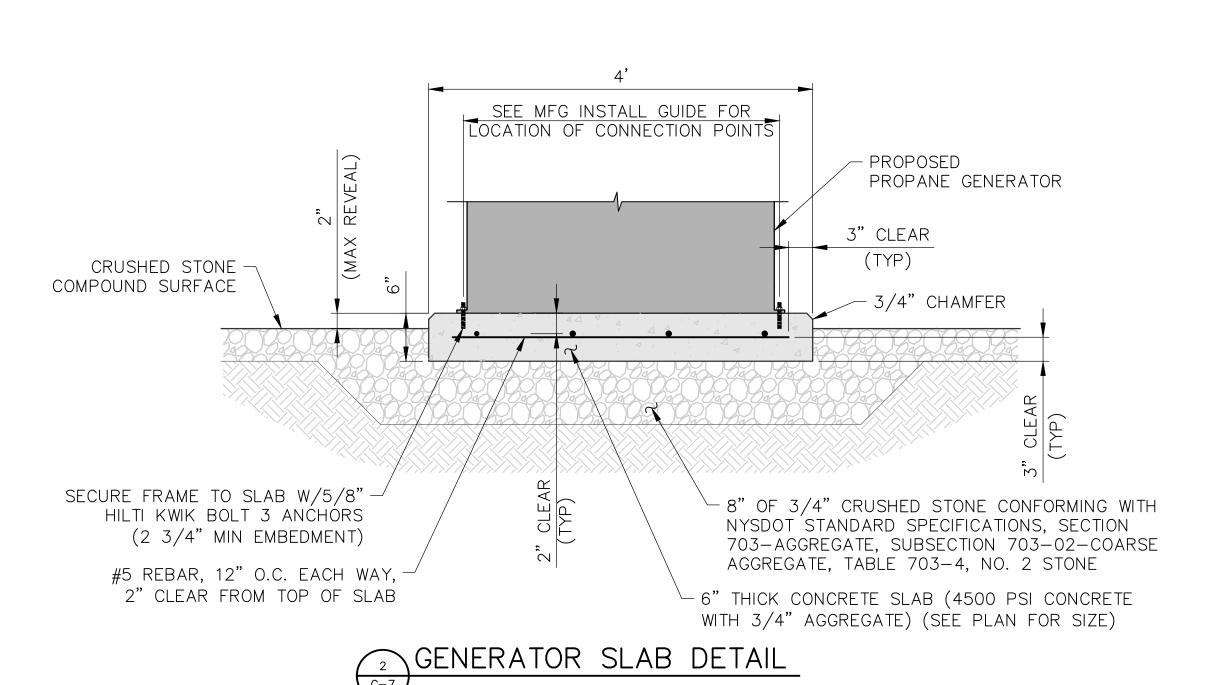

verizon V

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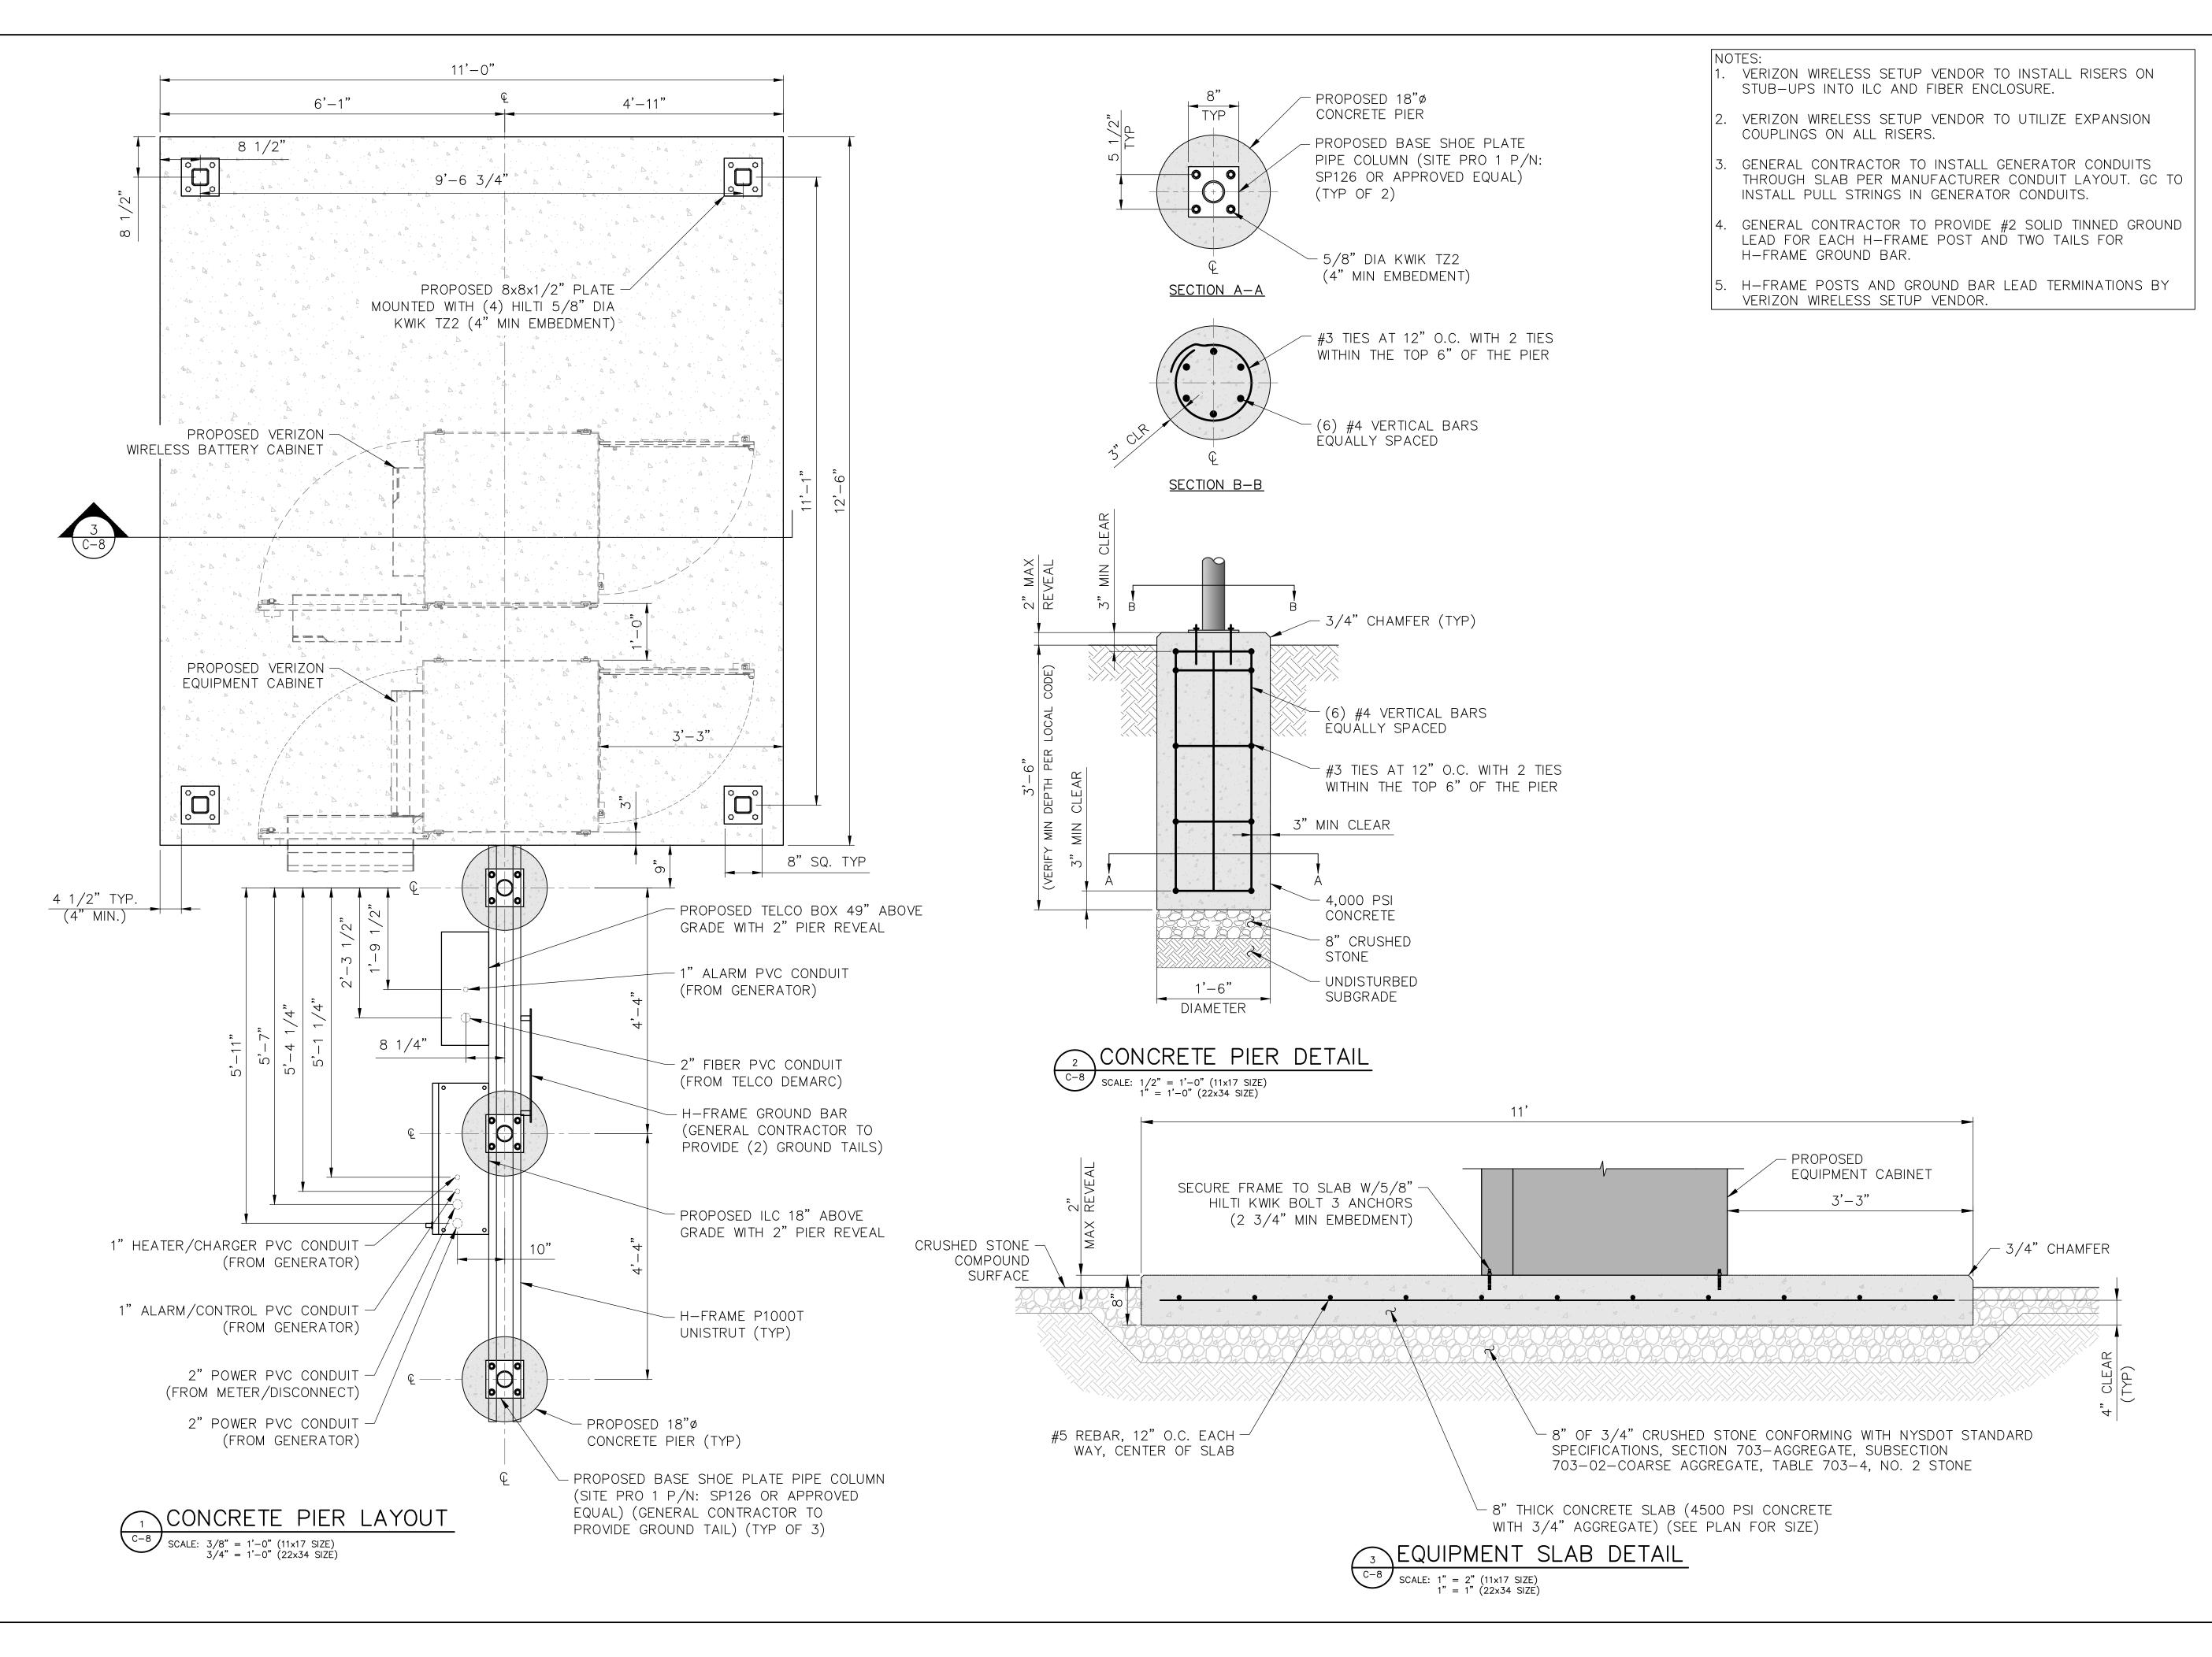
SITE ADDRESS

PUSKARENKO RD
TOWN OF STARK
HERKIMER COUNTY
NY 13361

SHEET TITLE

FOUNDATION PLAN & DETAILS

SHEET NUMBER





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> ORIGINAL SIZE IN INCHES SITE INFORMATION

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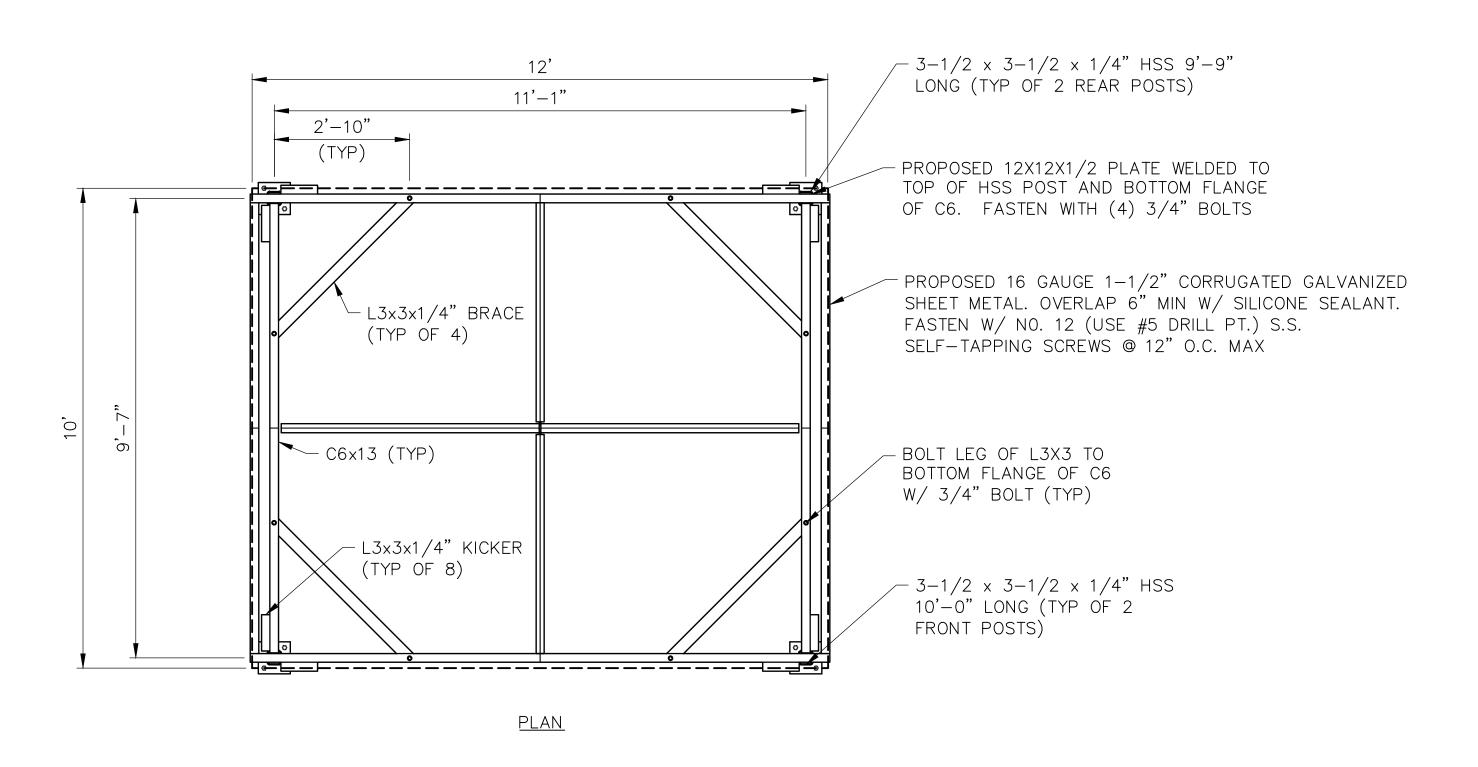
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PUSKARENKO RD TOWN OF STARK HERKIMER COUNTY


NY 13361 SHEET TITLE


PIER DETAILS

SHEET NUMBER



NOTE: ALL C6 CONNECTIONS TO BE DETAILED BY FABRICATOR AND SHALL COMPLY WITH ASTM STANDARDS.

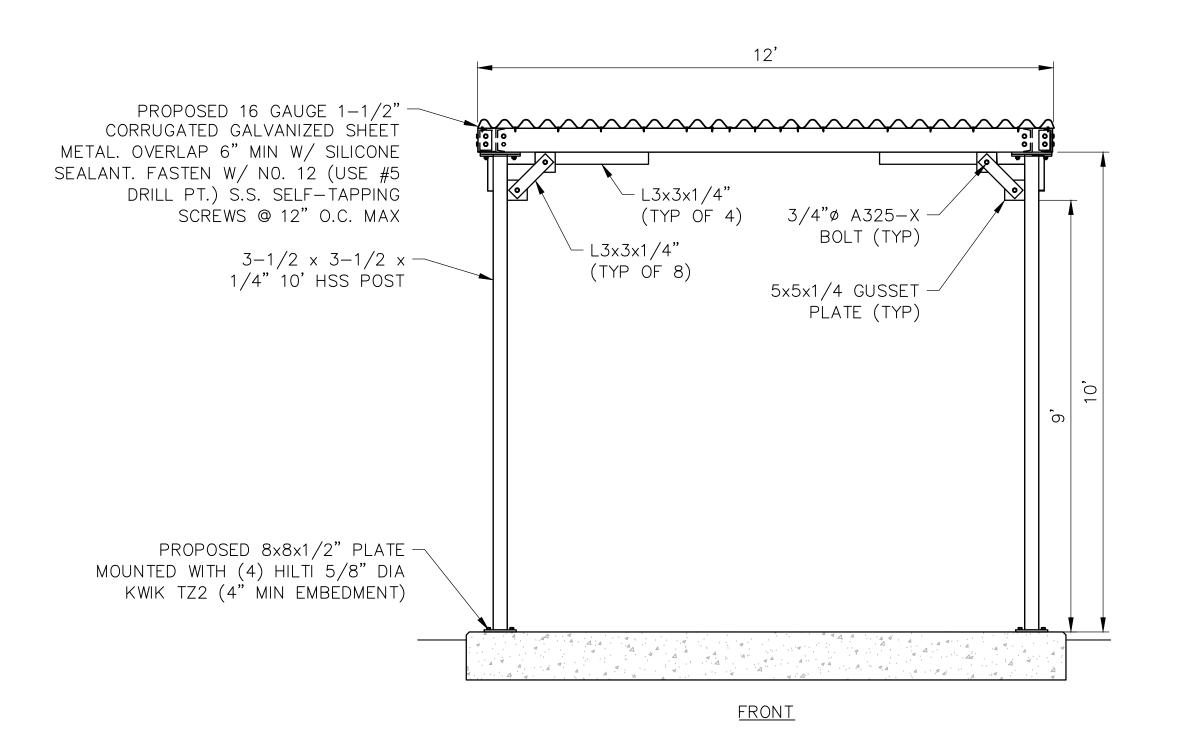

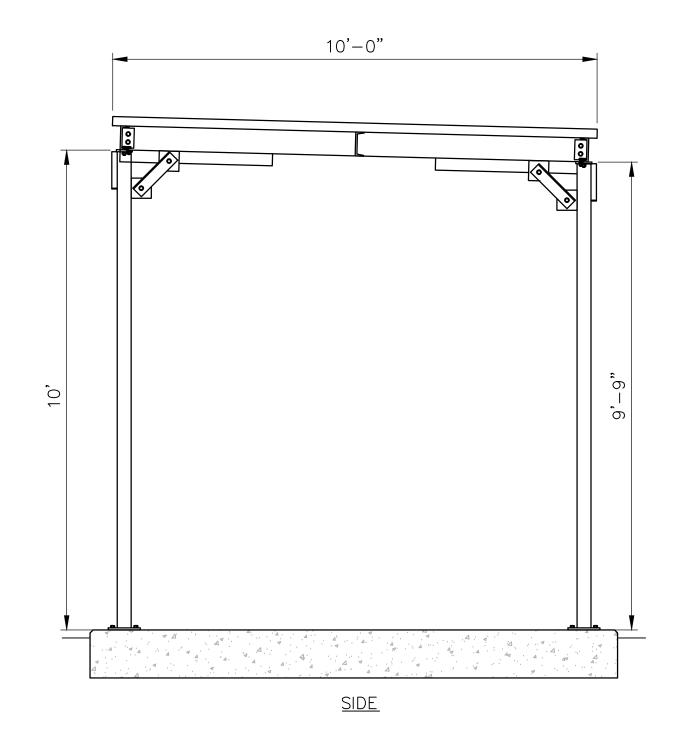

ICE CANOPY DETAIL

SCALE: NTS

verizon

1275 JOHN STREET, SUITE 100 WEST HENRIETTA, NY 14586



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ORIGINAL SIZE IN INCHES
SITE INFORMATION

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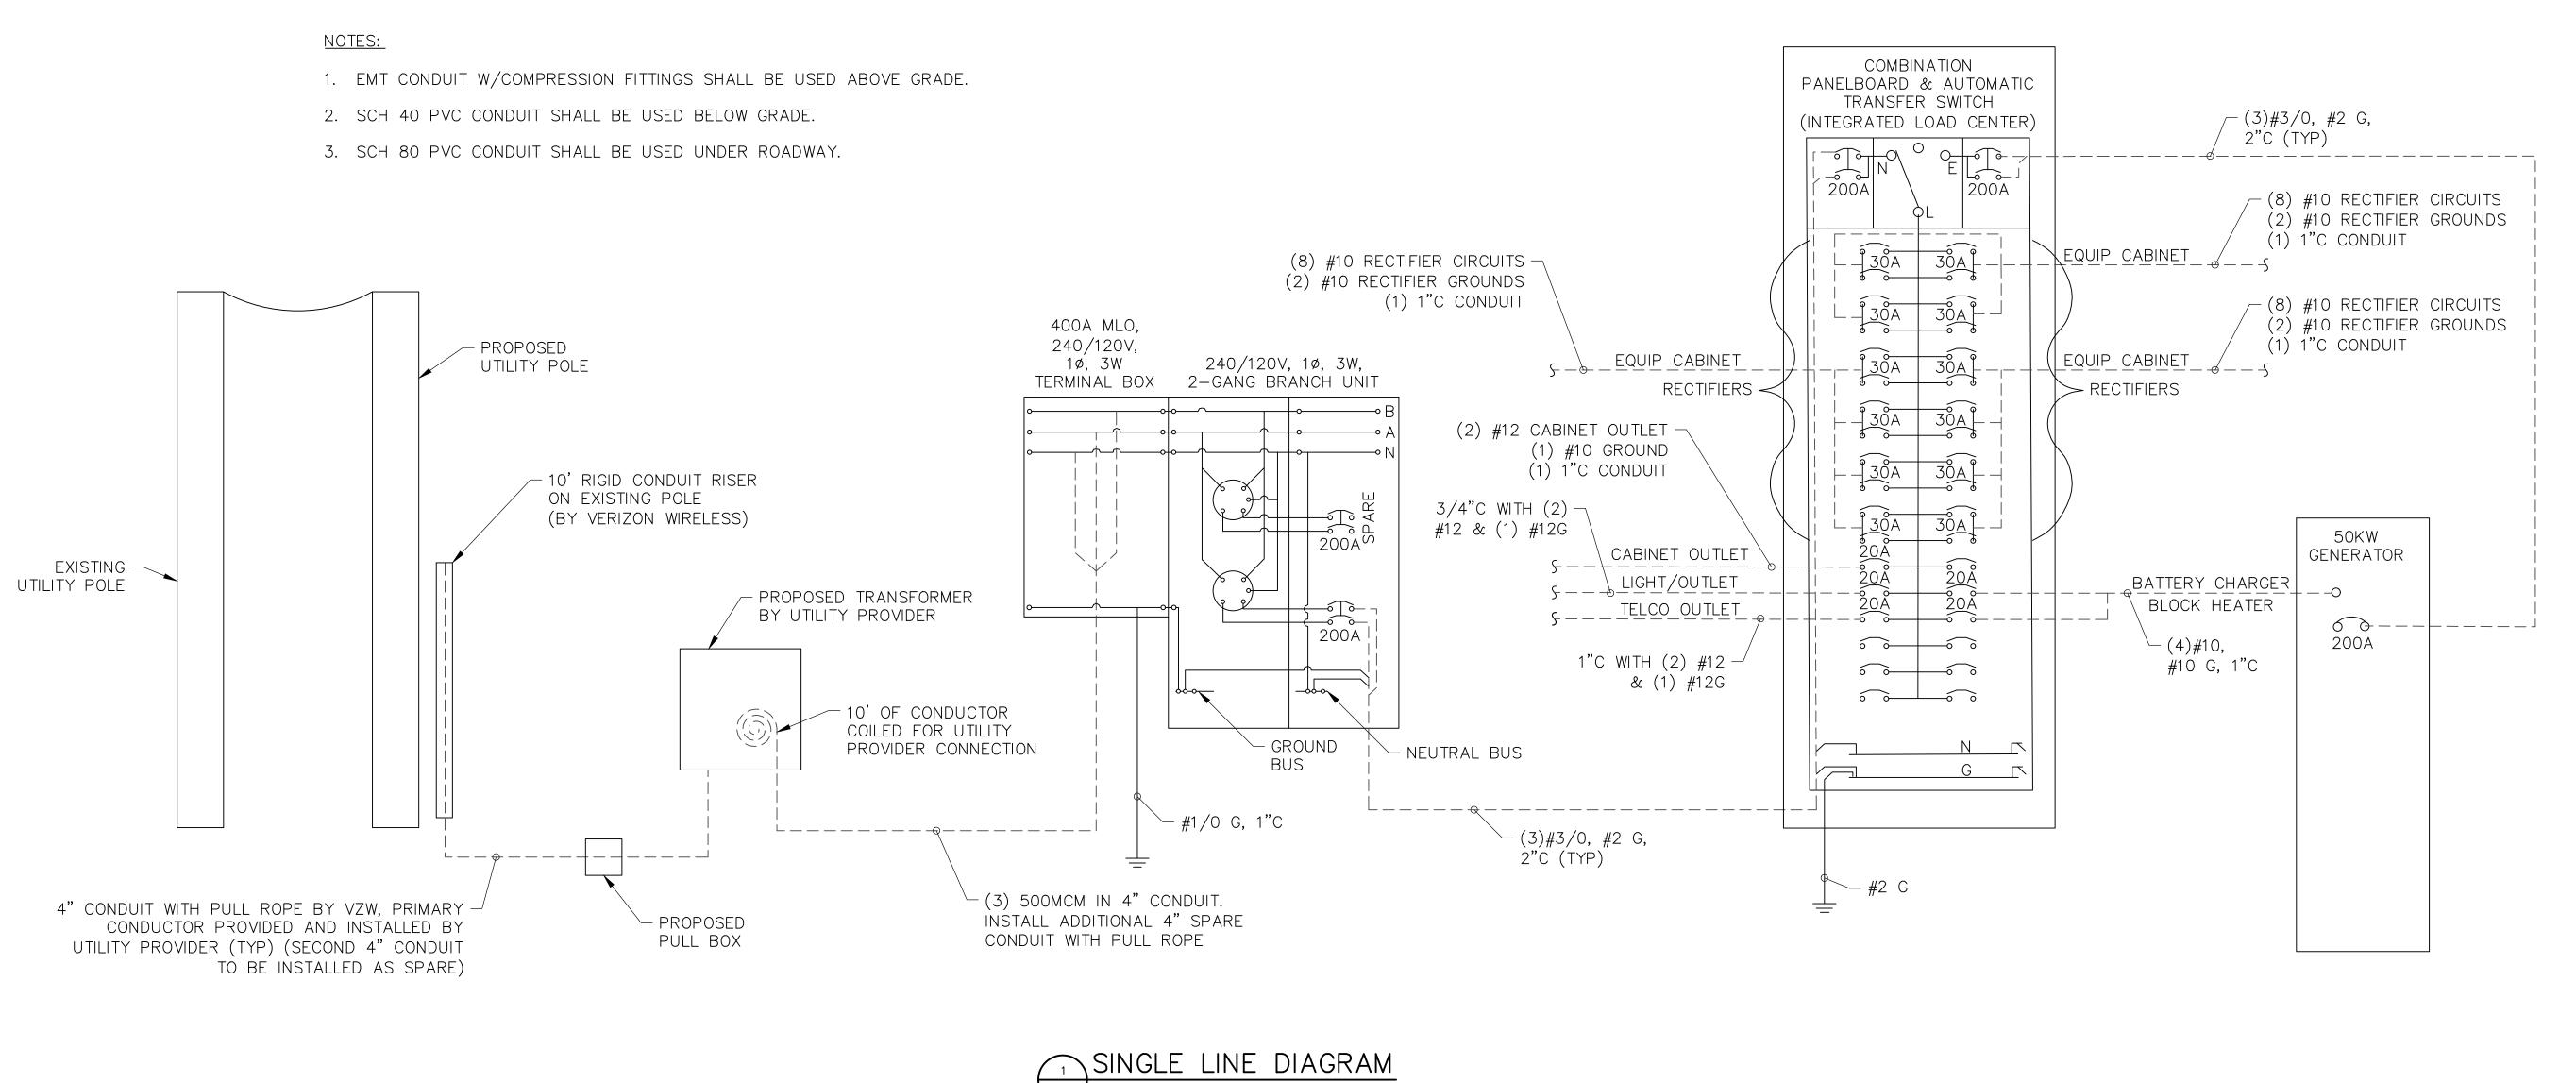
SITE ADDRESS

PUSKARENKO RD TOWN OF STARK HERKIMER COUNTY NY 13361

SHEET TITLE


ICE CANOPY DETAILS

SHEET NUMBER





DESIGN TO BE CONFIRMED AND UPDATED AS NEEDED PER VZW TELCO WALK REPORT

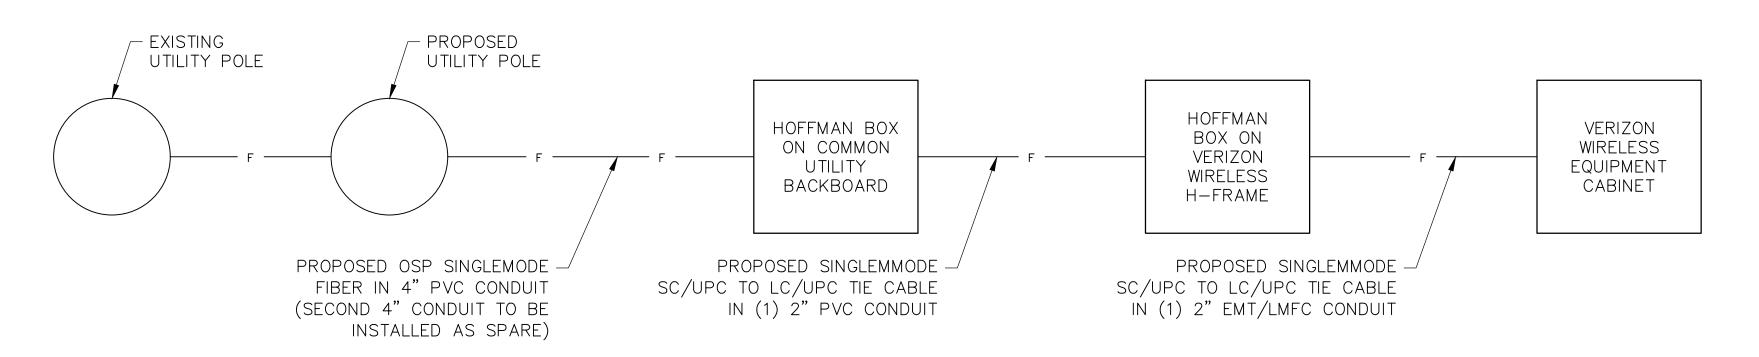





1275 JOHN STREET, SUITE 100 WEST HENRIETTA, NY 14586



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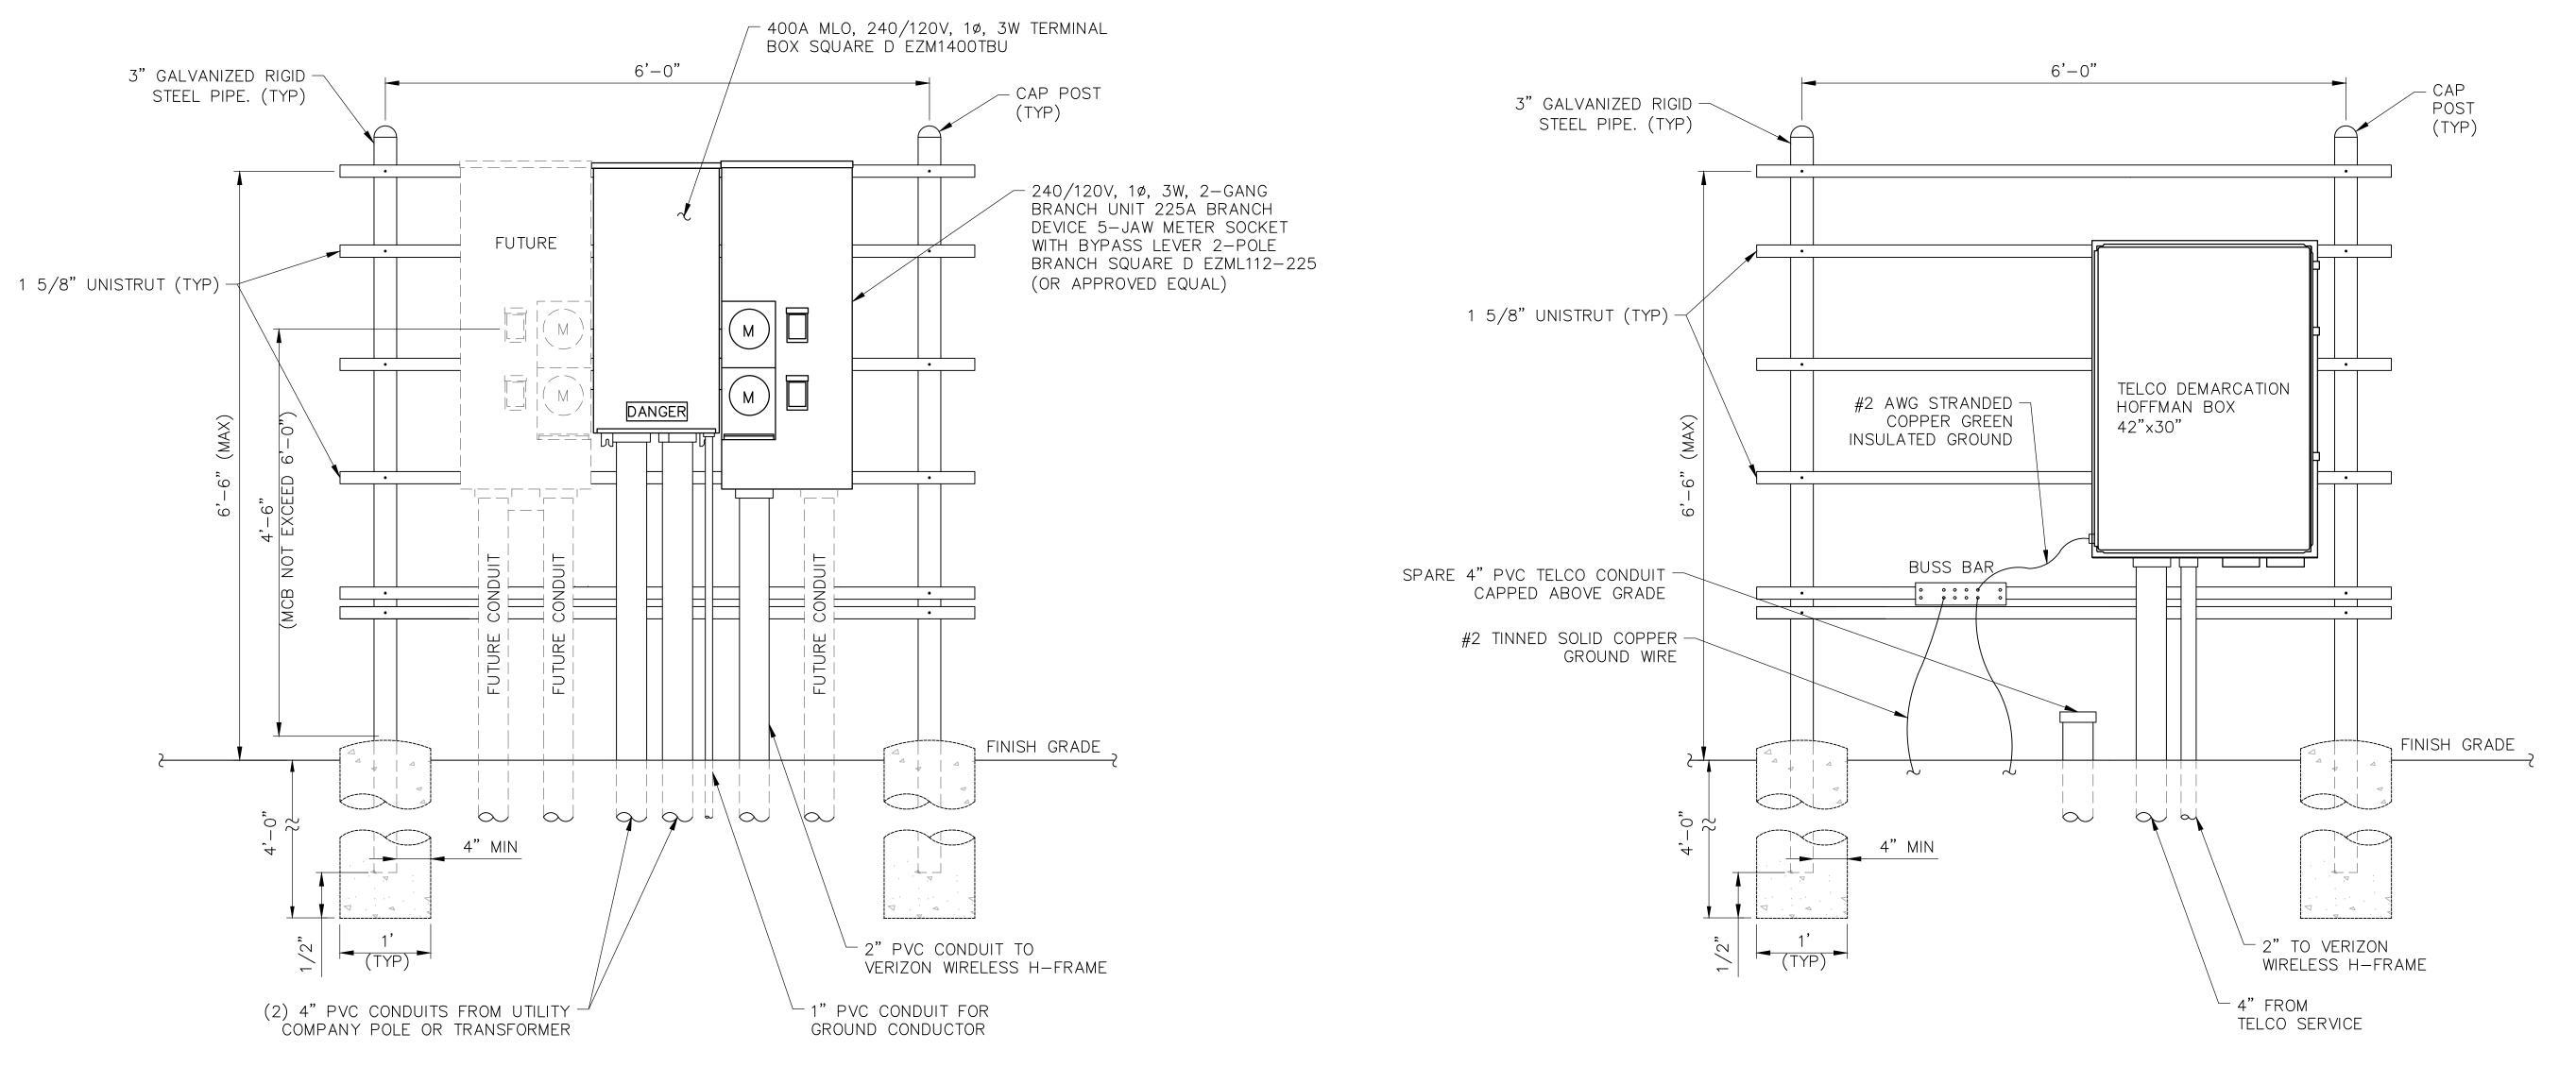
PUSKARENKO RD TOWN OF STARK HERKIMER COUNTY NY 13361

SHEET TITLE

UTILITY DIAGRAMS & DETAILS

SHEET NUMBER

E-1



<u>FRONT</u>

1. CONDUIT SHALL BE SCHEDULE 40 PVC CONDUIT 30" BELOW GRADE.

2. CONDUIT FROM 30" BELOW GRADE, INCLUDING THE SWEEP, SHALL BE SCHEDULE 80 PVC FOR ABOVE GRADE AND UNDER ALL ROADWAYS (UNLESS CONCRETE ENCASED).

3. ALL CONDUITS SHALL HAVE EXPANSION FITTINGS ABOVE GRADE.





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ORIGINAL SIZE IN INCHES SITE INFORMATION

VAN HORNESVILLE FUZE ID#: 17302851 MDG#: 5000921062

<u>REAR</u>

SITE ADDRESS

PUSKARENKO RD TOWN OF STARK HERKIMER COUNTY NY 13361

SHEET TITLE


UTILITY BACKBOARD DETAIL

SHEET NUMBER

E-2

LEGE	LEGEND							
M	METER	00000	COPPER GROUND BAR					
	CIRCUIT BREAKER		GROUND CONDUCTOR BY CONTRACTOR					
•	CADWELD TYPE CONNECTION BY CONTRACTOR		GROUND RING BY CONTRACTOR					
	COAXIAL CABLE SHIELD GROUND KIT CONNECTION	\otimes	GROUND ROD WITH TEST WELL					
•	COMPRESSSION FITTING GROUND CONNECTION		GROUND ROD					

ABBREVIATIONS							
А	AMPERE	W	WIRE				
С	CONDUIT	WP	WEATHERPROOF				
GND	GROUND	Ø	PHASE				
KWH	KILOWATT HOUR	TGB	TOP GROUND BAR				
Р	POLE	MGB	MASTER GROUND BAR				
SN	SOLID NEUTRAL	BGB	BOTTOM GROUND BAR				
SW	SWITCH	EGB	EXISTING GROUND BAR				
V	VOLT						

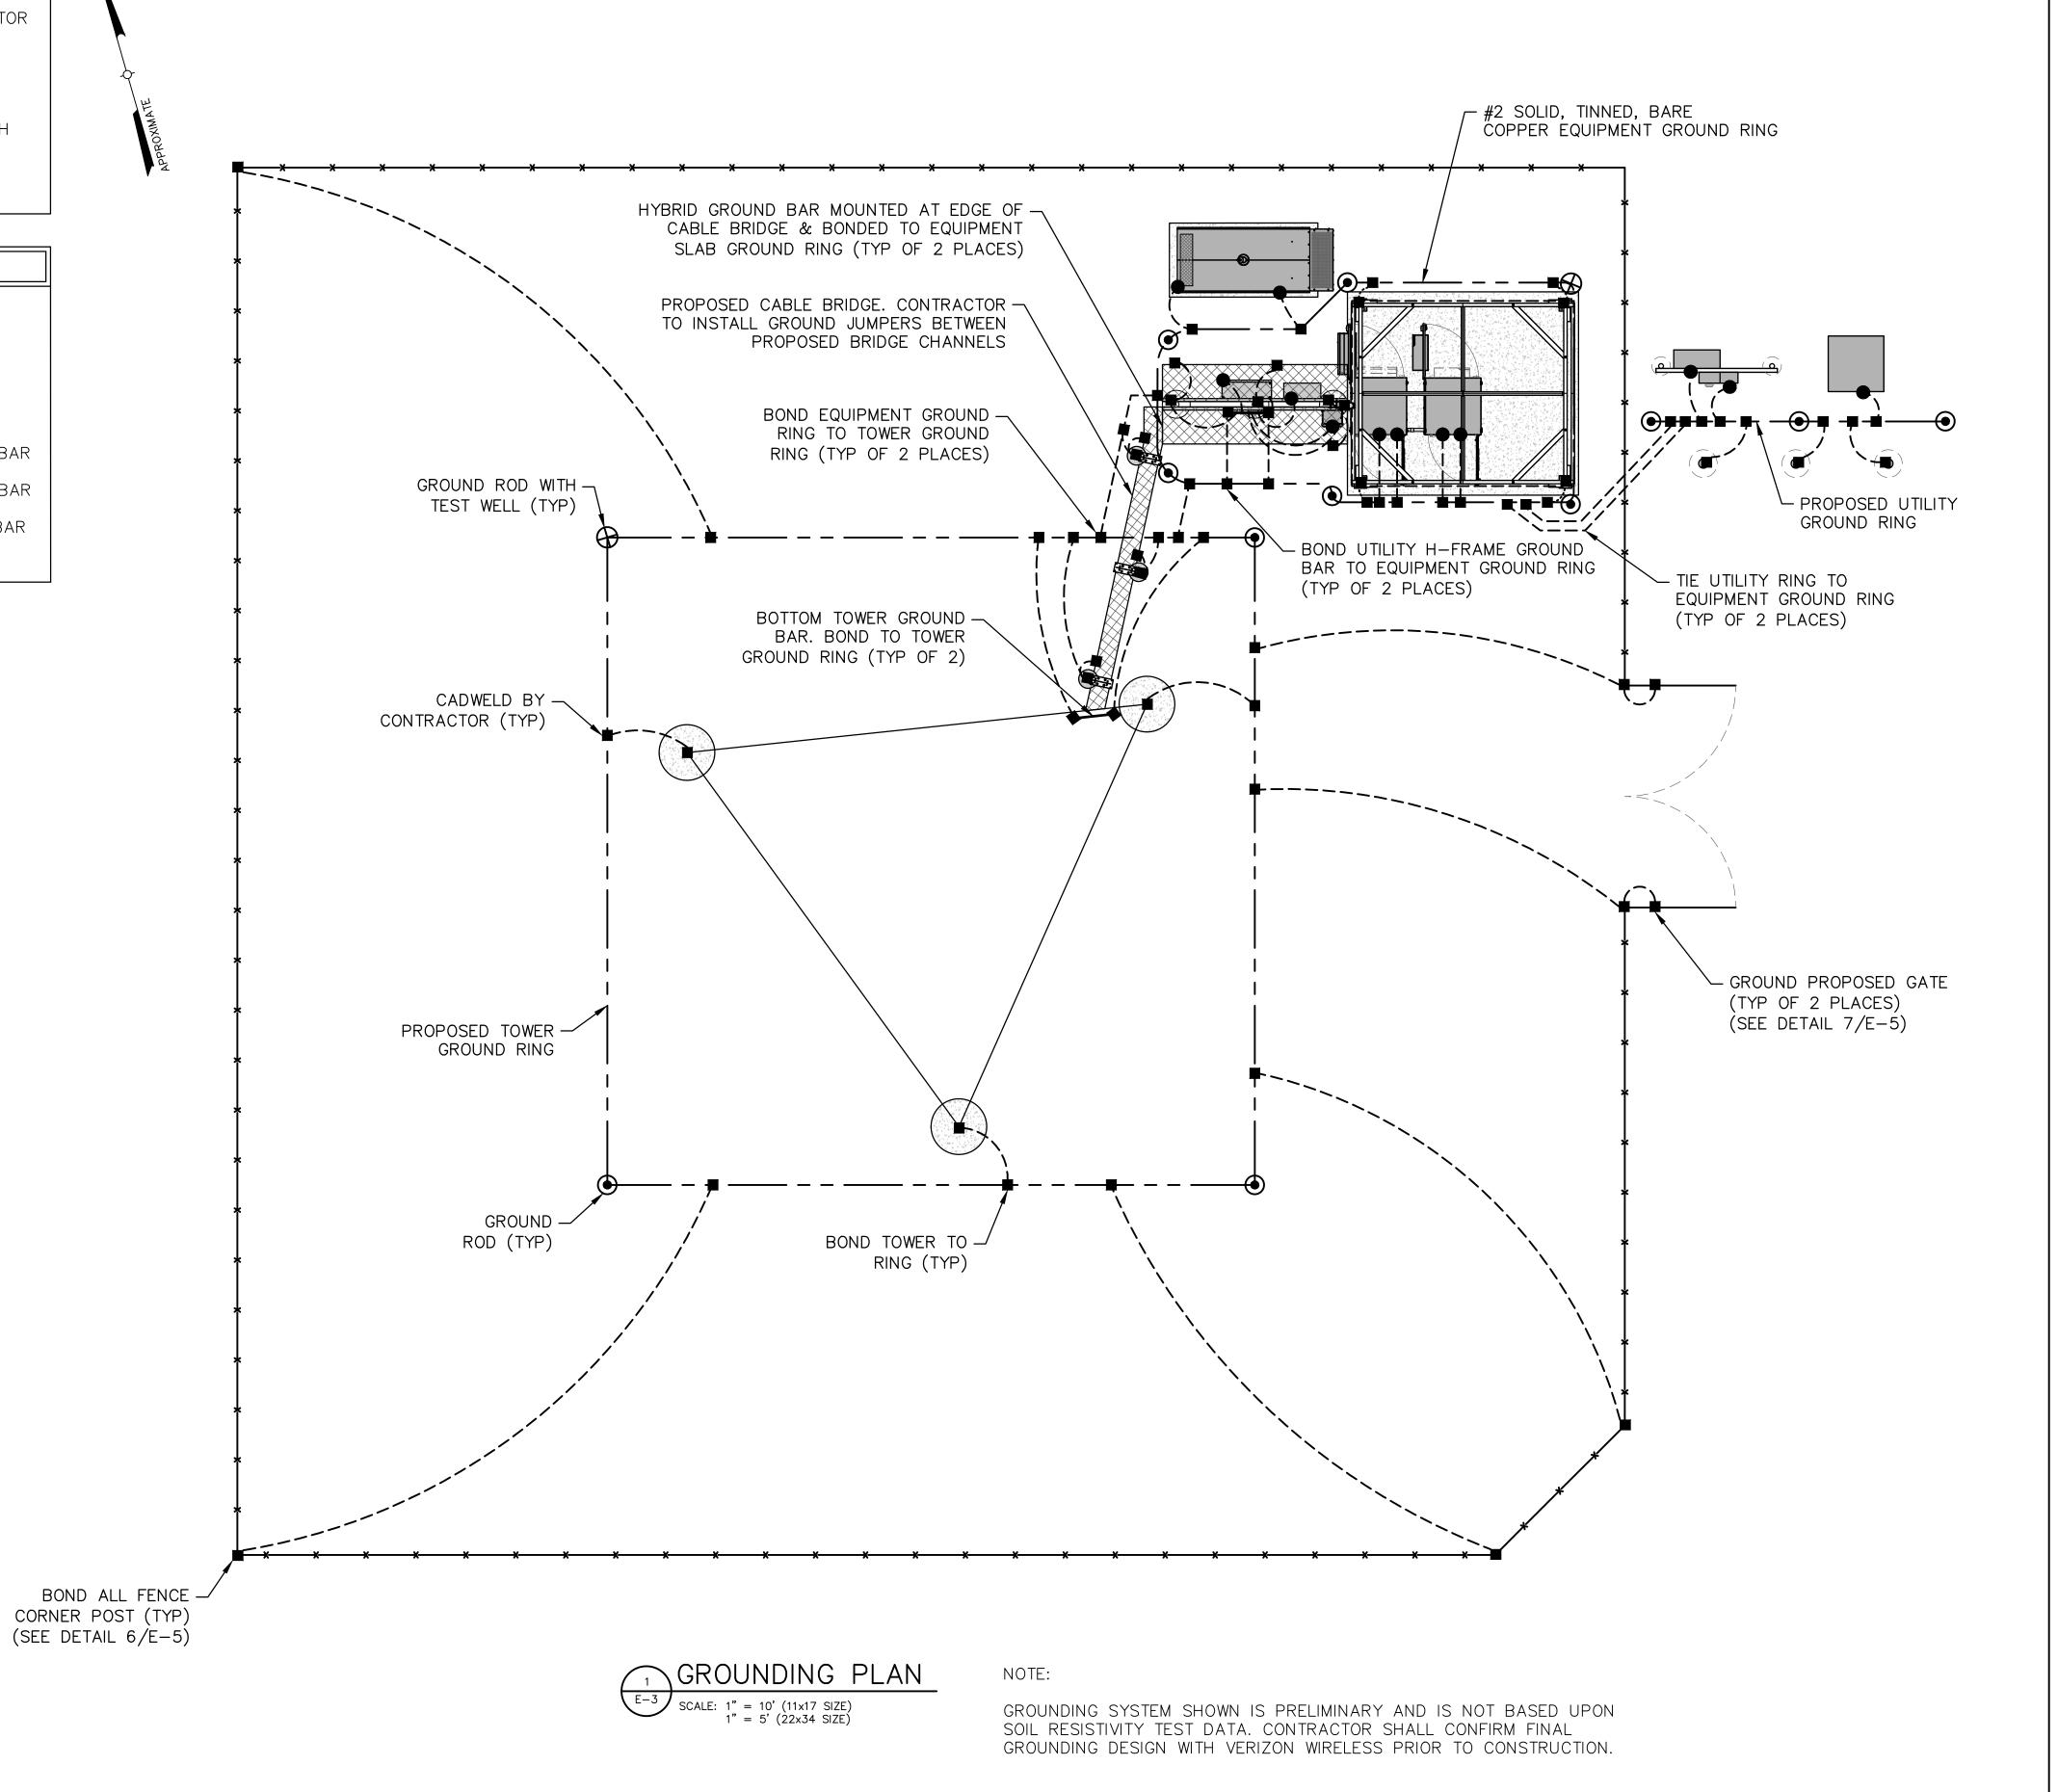



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SITE ADDRESS

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HERKIMER COUNTY
NY 13361

SHEET TITLE

GROUNDING PLAN

SHEET NUMBER

E-3

